

PROPOSED BUILDING AT 53 HELVETIA ROAD, PUKEKOHE, AUCKLAND

SHEET NO.	SHEET NAME.	SHEET NO.	SHEET NAME.	SHEET NO.	SHEET NAME.
1.01	SITE PLAN - EXISTING	3.01	ELEVATION - NE&SE	6.01	TYPICAL ROOF DETAILS 1
1.02	SITE PLAN - PROPOSED	3.02	ELEVATION - NW&SW	6.02	TYPICAL ROOF DETAILS 2
1.03	SITE PLAN - DRAINAGE PLAN			6.03	TYPICAL ROOF DETAILS 3
1.04	SITE PLAN - EARTHWORK PLAN	4.01	CROSS SECTION A	6.04	TYPICAL WINDOW DETAILS 1
		4.02	CROSS SECTION B	6.05	TYPICAL WINDOW DETAILS 2
2.01	FLOOR PLAN			6.06	TYPICAL CLADDING DETAILS 1
2.02	FLOOR PLAN - DIMS			6.07	TYPICAL CLADDING DETAILS 2
2.03	FOUNDATION & JOIST PLAN			6.08	TYPICAL FOUNDATION EDGE DETAILS
2.04	ROOF PLAN			6.09	TYPICAL CRAFT DETAILS 1
				6.10	TYPICAL CRAFT DETAILS 2
				6.11	TYPICAL WET AREA DETAILS
				6.12	TYPICAL FRAMING DETAILS
				6.13	TYPICAL BOTTOM PENETRATION DETAILS


HILDING PRACTIFICATION OF THE PROPERTY OF THE	T E
www.dbh.govt.nz	1
WG CONFIDE	


OCUMENT AND THE COPYRIGHT IN THIS MENT REMAIN THE PROPERTY OF ACG	ISSUE:	DATE:	DOCUMENTS VERSION:
TECTURE LTD.	BC 1	04/24	BUILDING CONSENT ISSUE
EREYE ROAD, HOBSENVILLE, AUCKLAND	100 1	01/21	BOILDING BONSENT 1330.
EMAIL: ACGARCHNZ@HOTMAIL.COM			


PROPOSED NEW DWELLING AT 53 HELVETIA ROAD, PUKEKOHE, AUCKLAND LOT 1, DP 50263 SHEET NAME: COVER PAGE


DRAWN BY: SHEET NO: 23/2223 DESIGNED BY: H.C DATE: 01/05/2024 DRAWN SCALE:

0.00

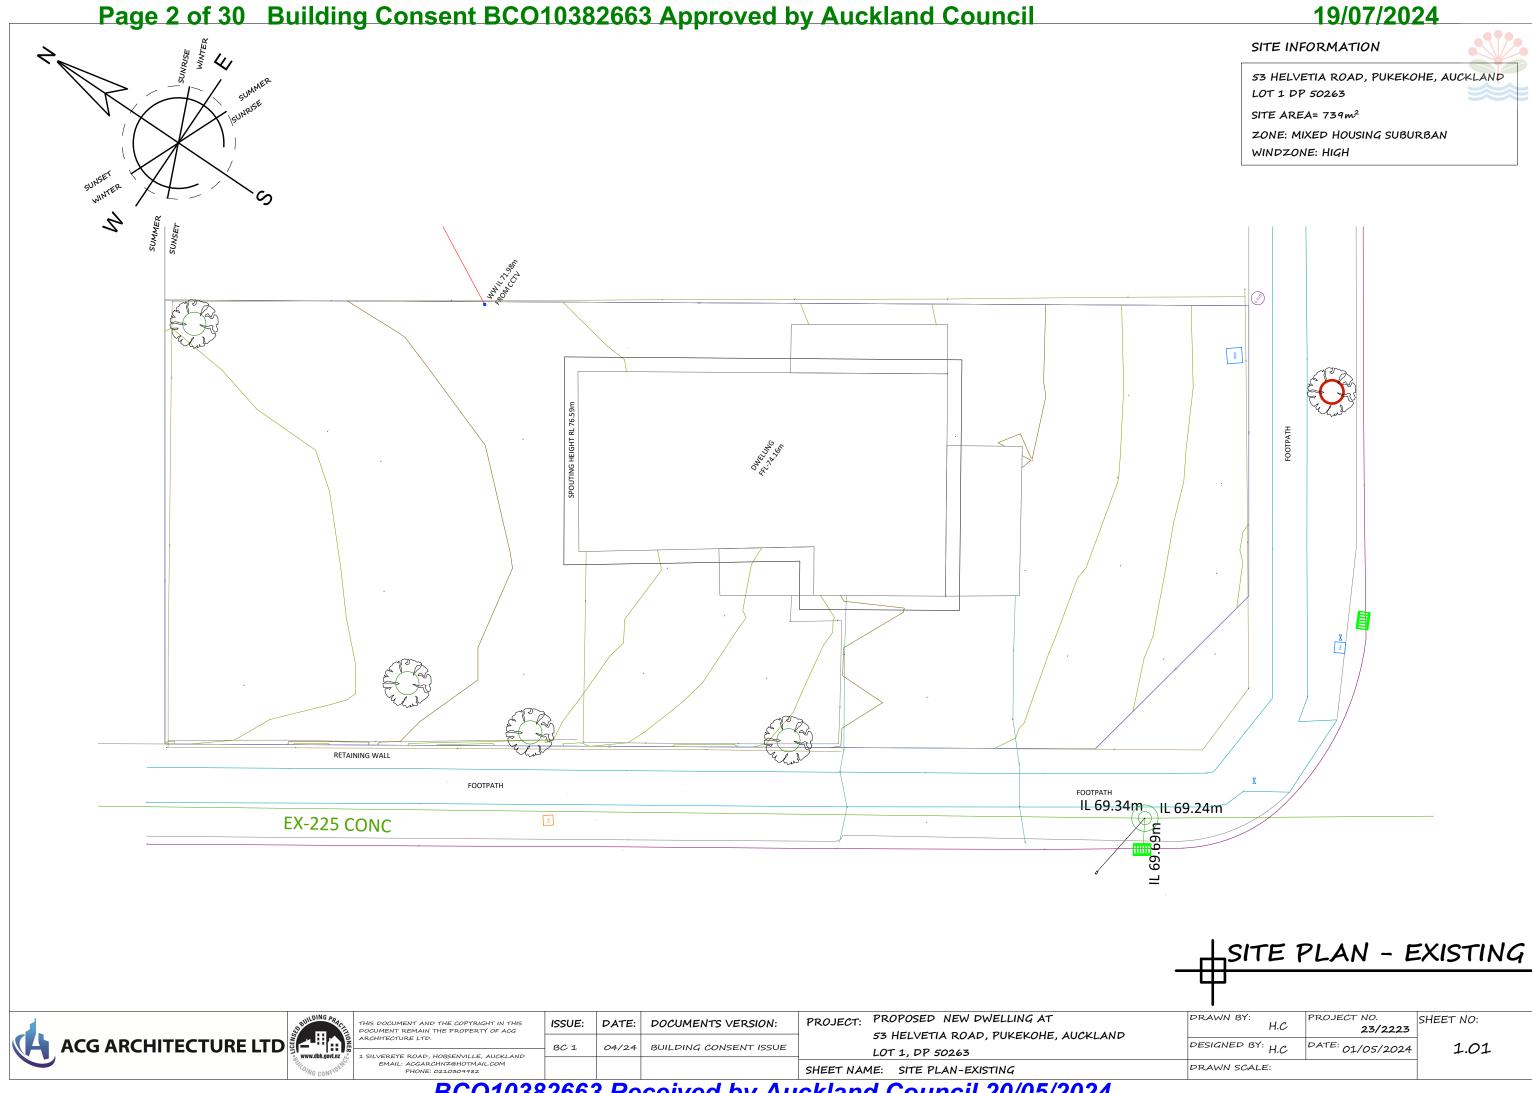

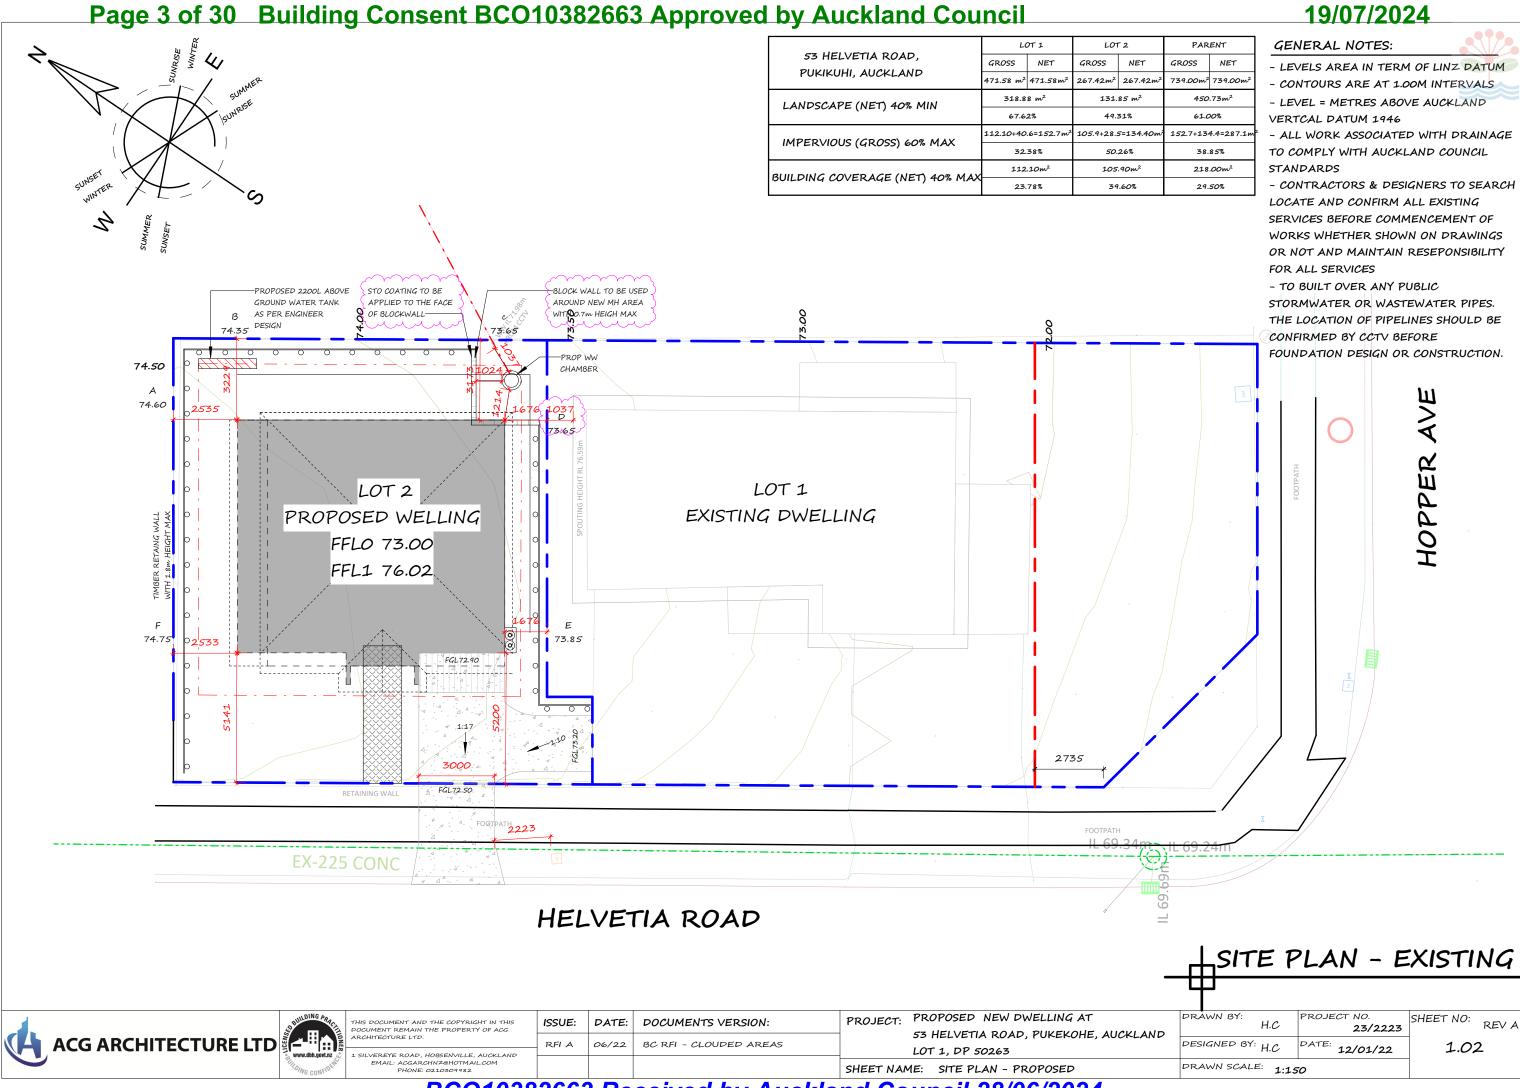

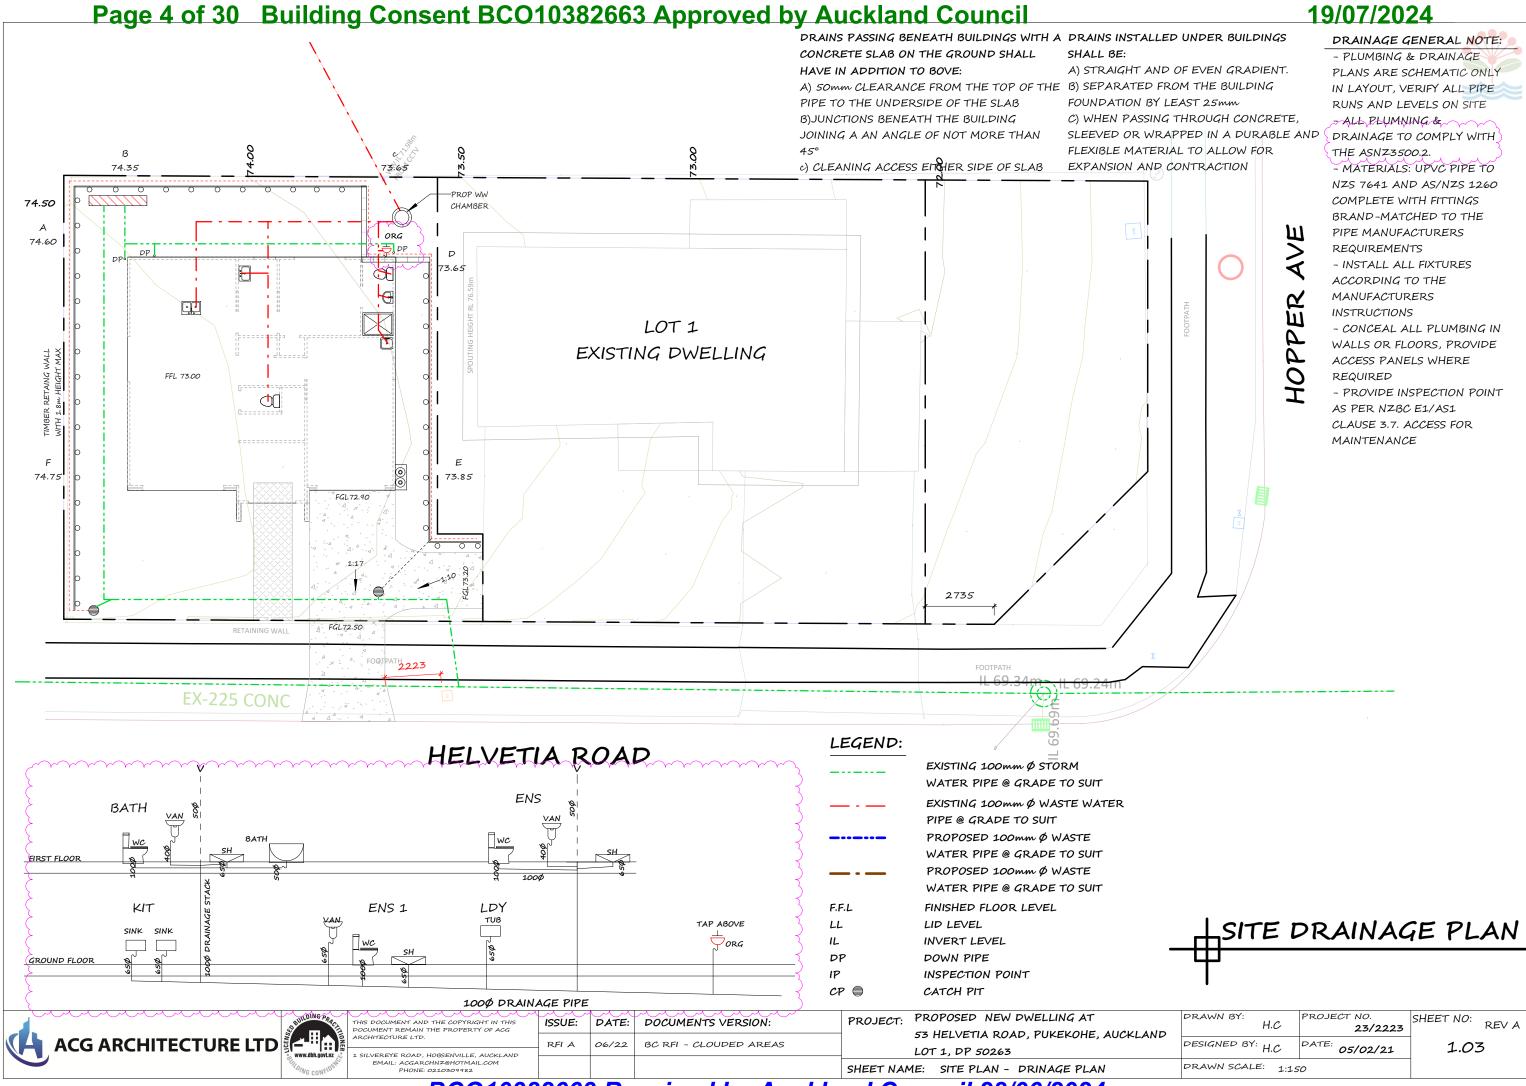

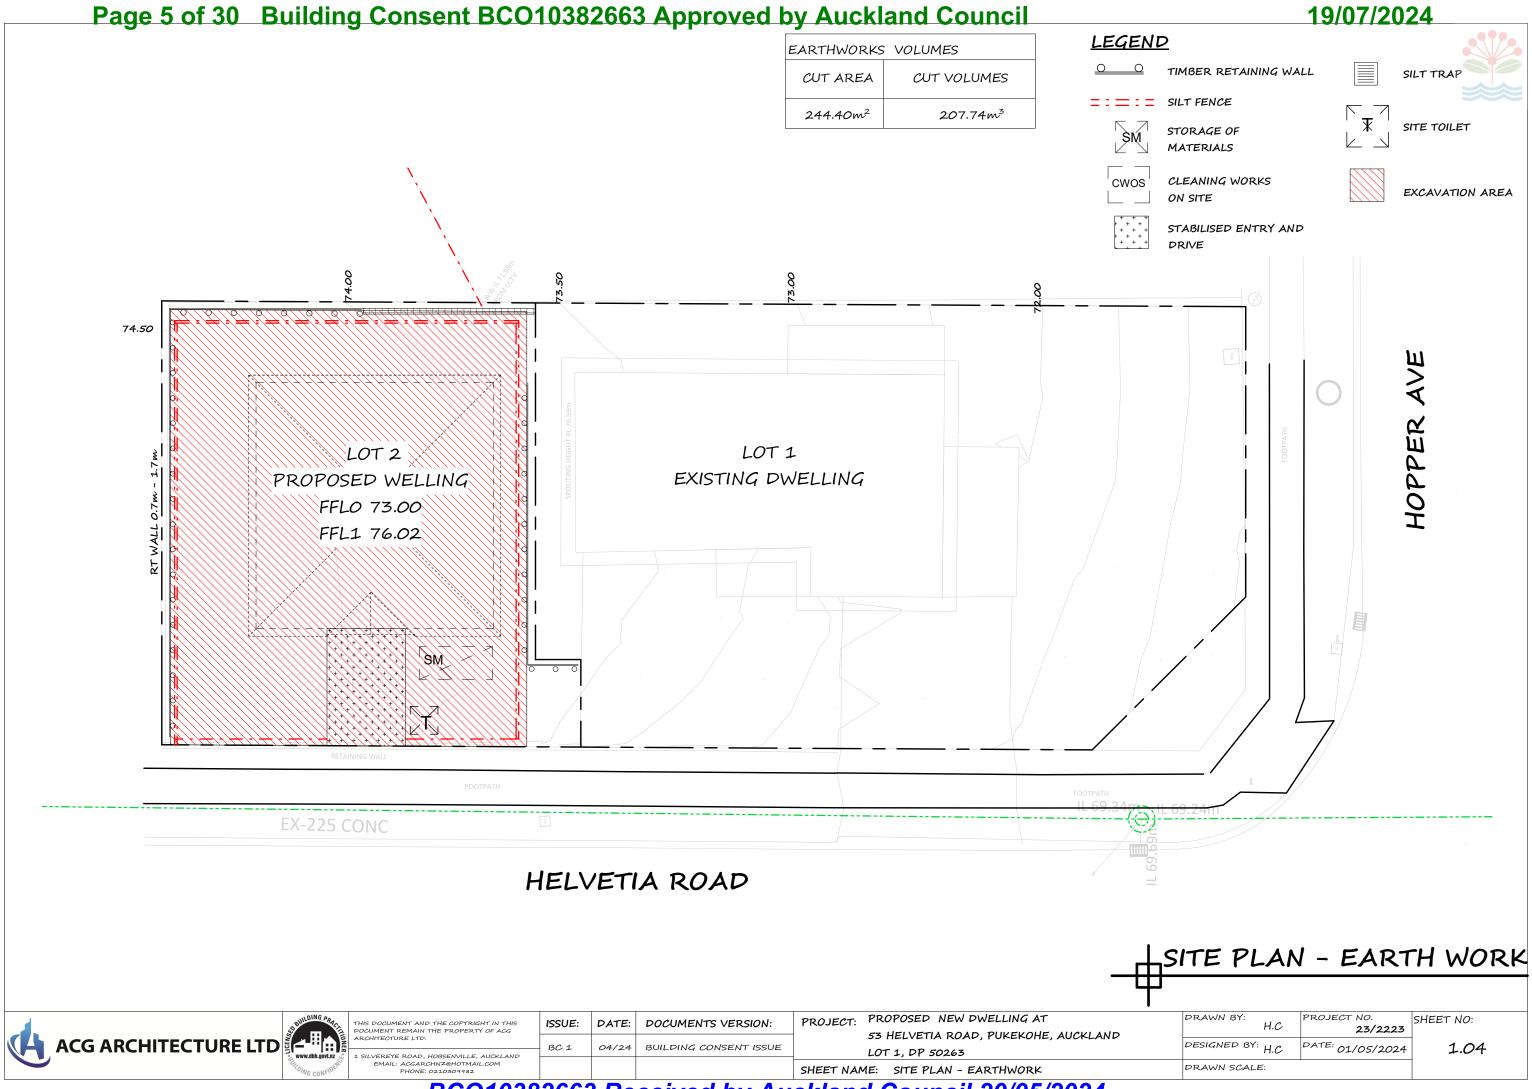

19/07/2024

Lintel Schedule Lintel | Timber Size Timber Type 2/140 x 45 SG8 2/190 x 45 2/290 x 45 Refer to engineer Eng

WALL LEGEND:

NOTE 1:

SPECIFIC NOTES:

BATH & ENSUIT TO BE VENTED TO THE EXTERIOR (THROUGH WALL OR SOFFIT)

NOTE 2:

DINING

LIVING

2300HX3200W B/FOLD

40mm Min.DIA HANDRAIL FIXED TO SIDE OF THE STAIRWAY WALL TO COMPLY WITH NZBC NOTE 4: DI/ASI, 900mm Min HIGH FROM STAITWAY NØSING.

NOTE 3:

STAIR TREADS AND RISERS TO MANUFACTURER'S DESIGN AND DETAILS, WITH 17 RISERS AT 177.60mm AND 270mm TREADS WITH 10MM NOSING. STAIR DESIGNED AS A 'SECONDARY PRIVATE' STAIRWAY AS PER TABLE 6 NZBC D1

BUILDING OUTLINE ABOVE

190mmx45 @400 CRS OVER

BLOCK FOR GROUND FLOOR

2/45kg GAS BOTTLES 1m Min CLEARANCE ON CONCTETE PLINTH WITH SEISMIC SAFETY RESTRAINT AROUND THE BOTTLE

1200H x 2100W

BED 4

 \otimes sd

SMOKE ALARMS:

\otimes SD DENOTES SMOKE DETECTOR WITH PUSH BUTTON

- SMOKE DETECTORS TO BE INSTALLED THROUGHOUT DWELLING IN COMPLIANCE WITH F7/AS1 OF THE NZBC
- THERE MUST BE A SMOKE DETECTOR WITHIN 3.0M OF EACH BEDROOM DOOR AND TO ALL ESCAPE PATHS. SMOKE DETECTORS TO BE MOUNTED ON CEILING NOT MORE THAN 300MM BELOW HIGHEST PART OF ROOM.

1200H x 2100W

BED 3

ENS

 \otimes

SD

GENERAL NOTES:

- · ALL WORK TO COMPLY WITH NZS3604:2011 & NZ BUILDING CODE
- TRUSS & ENGINEER DESIGN TO INFORM K & J ARCHITECTURE LTD IF THERE IS ANY POINT LOAD OR GIRDER TRUSS IS SUPPORTED OVER A WINDOW OR DOOR OPENING.
- · JOINERY MANUFACTURE TO CHECK & CONFIRM ALL WINDOW OPENING SIZE ON SITE PRIOR TO FABRICATION.
- · ALL INTERNAL DOOR TO BE 2200MM HIGH STANDARED FLUSH PANEL DOOR WITH SFI FCTFD HARDWARF
- · GIB AQUALINE LINE TO ALL WET AREAS.
- · ALL EXPOSED AND SUB FLOOR STRUCTURAL FIXIGS TO BE STAINLESS STEEL IN CORROSION ZONE C & D (SEA SPRAY ZONE).
- · ALL LINTEL & STRUCTURAL BEAMS TO BE CONFIRMED WITH ENGINEER DESIGN & DETAILS.
- · SAFETY GLASS TO BE USED IN THE BATH AND TOILET AS PER NZBC F2.
- · ALL EXTERNAL PAVE AND INTERNAL FLOOR TILES TO BE COMPLY WITH TABLE 2 ACCEPTABLE SLIP RESISTANCE IN SECTION D1/AS1
- · CA RATE OF DOWN LIGHT TO BE COMPLIED WITH C/AS1 7.4 DOWNLIGHTS AS/NZS 60598.2.2


TIMBER FRAMING NOTES:

- · CONFIRM ALL TIMBER SIZE PRIOR TO ANY COMMENCING WORK
- · ALL LINTEL AND STRUCTURAL ELEMENT TO BE CHECKED BY ENGINEER
- · ALL TIMBER TO BE H1.2 TREATED EXCEPT WHERE NOTED OTHERWISE OR REQUIRED BY NZBC: B2/AS1
- · ALL TIMBER TO BE SG8 UNLESS NOTED OTHERWISE

FRIDGE

PANTRAY

90 X 45 TIMBER FRAME WITH STUDS @ 400 CTRS & NOGS @ 800mm MAX VERTICALLY 90 X 45 TIMBER FRAME WITH STUDS @ 600 CTRS & NOGS @ 800mm MAX VERTICALLY (ER) 88 KITCHEN

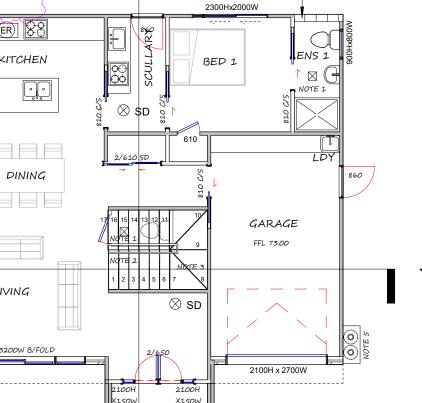

4.02 MASTER BED BED 2 MOD 200Hx1200W

FIRST FLOOR PLAN

4.01

BATH

FFL 76.20

CLADDING:

NIAGARA TIMBER VERTICAL SHIPLAP & HORIZONTAL WEATHERBOARD

70 SERIES BRICK VENNER

INTERNAL LININGS:

- 10MM STD/GIB BOARD TO ALL CEILING
- 10MM STD/GIB BOARD TO EXTERNAL & INTERNAL WALL LINING; EXCEPT AQUALINE TO WET AREA;
- BRACELINE AS PER BRACING LAYOUT, REFER TO ENGINEER DESIGN REPORT,

FLOOR:

H3.2 19MM PLYWOOD TO WET AREA ON H1.2 FLOOR

GROUND FLOOR - CONCRETE SLAB

WATERPROOFING:

GROUND FLOOR PLAN

INTERIOR WET AREA - TECHNOKOLLA INTERNAL WATERPROOFING MEMBRANE

FLASHING TAPE - THERMAKRAFT ALUBAND WINDOW FLASHING TAPE

EXTERIOR JOINERIES:

POWDER COATED ALUMINUM FRAMES/DOUBLE GLAZED JOINERIES WITH LOW E

INTERNAL WALL FRAMING:

GROUND FLOOR: WALL H=2.72M, 90X45 H1.2 SG8 STUDS@600CRS WITH NOGS@800CRS(VERTICALLY) FIRST FLOOR: WALL H=2.42M, 90X45 H1.2 SG8 STUDS@600CRS WITH NOGS@800CRS(VERTICALLY)

TOP/BOTTOM PLATE:

TOP PLATE: EXTERNAL/LBW - H1.2 90 X 45 + 140 X 35 SG8

NON LBW - H1.2 90 X 45 SG8

BOTTOM PLATE: ALL WALLS - H1.2 90 X 45 SG8 BUILDING WRAP:

WALL - THERMAKRAFT WATERGATE PLUS ROOF - THERMAKRAFT 407 ROOF UNDERLAY INSULATION:

EXTERIOR WALL - 90MM THICK R2.2 PINK BATTS ROOF - R7.0 THICK PINK BATTS UNDER MID FLOOR - 90MM R2.2 THICK PINK BATTS

LEGEND:

 \boxtimes

TOWER RAIL

MECHANICALLY EXTRACTOR FAN


6.16

GAS INFINITY HOT WATER EXTERIOR UNIT

RANGE HOOD ABOVE

FUSE BOX

FIBRE OPTIC

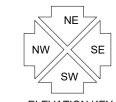

ELEVATION KEY

REV A





THIS DOCUMENT AND THE COPYRIGHT IN T DOCUMENT REMAIN THE PROPERTY OF AC ARCHITECTURE LTD.
1 SILVEREYE ROAD, HOBSENVILLE, AUCKLA

DOCUMENTS VERSION: ISSUE: DATE: RFI A 06/22 BC RFI - CLOUDED AREAS PROJECT:

PROPOSED NEW DWELLING AT 53 HELVETIA ROAD, PUKEKOHE, AUCKLAND LOT 1, DP 50263 SHEET NAME: FLOOR PLAN


DRAWN BY PROJECT NO H.C23/2223 DESIGNED BY: H.C DATE: 03/19/24 DRAWN SCALE


F

P

SHEET NO: 2.01



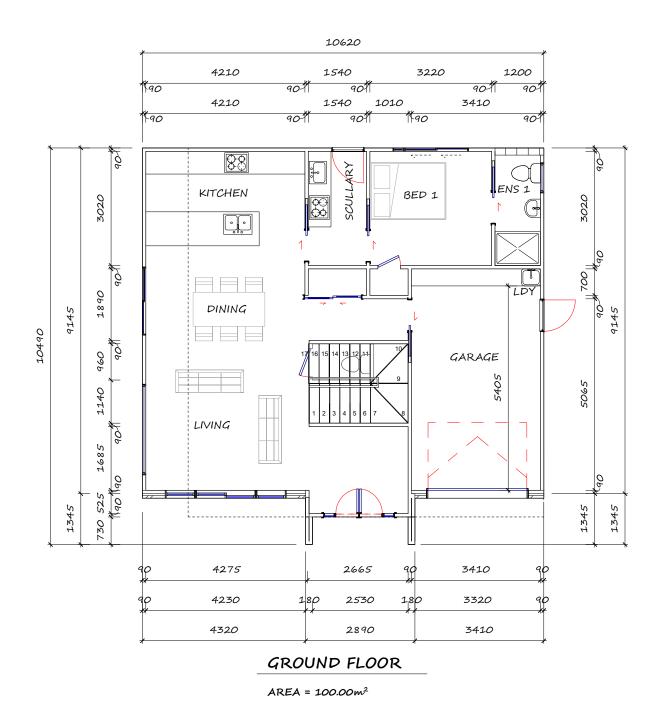

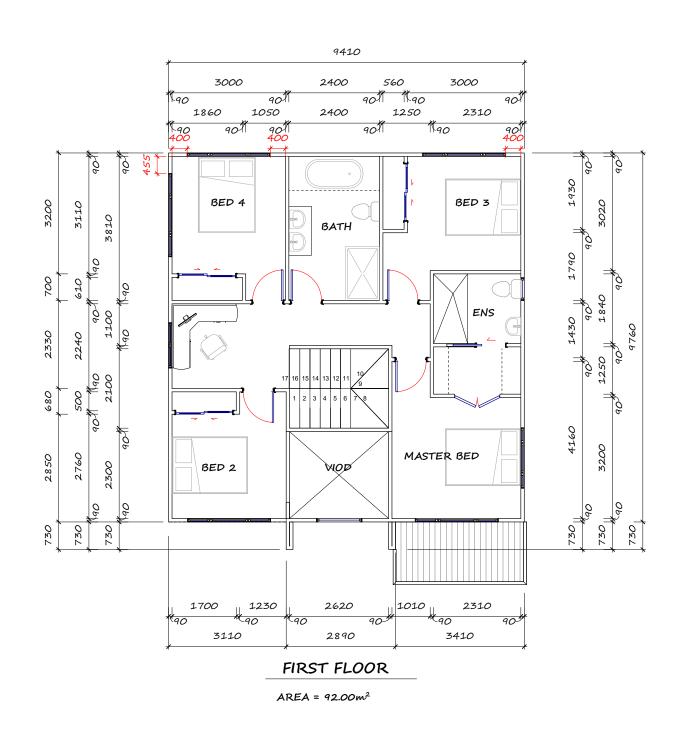

DIMENSIONED FLOOR PLAN





HIS DOCUMENT AND THE COPYRIGHT IN THIS OCUMENT REMAIN THE PROPERTY OF ACG	ISSUE:	DATE:	DOCUMENTS VERSION:
RCHITECTURE LTD.	BC 1	04/24	BUILDING CONSENT ISSU
SILVEREYE ROAD, HOBSENVILLE, AUCKLAND			,
EMAIL: ACGARCHNZ@HOTMAIL.COM			

PROPOSED NEW DWELLING AT 53 HELVETIA ROAD, PUKEKOHE, AUCKLAND LOT 1, DP 50263 SHEET NAME: FLOOR PLAN - DIMS

DRAWN BY: H.C	PROJECT NO. 23/2223	SHEET NO:
DESIGNED BY: H.C	DATE: 01/05/2024	2.02
DRAWN SCALE: 1:10	0	

Page 8 of 30 Building Consent BCO10382663 Approved by Auckland Council

* ALL DRAINAGE WORKS TO BE IN ACCORDANCE WITH AS/NZS 3500, NEW ZEALAND BUILDING CODE (NZBC) AND AUCKLAND CITY COUNCIL INFRASTURE DESIGN STANDARDS.

NOTES.

* CONTRACTOR TO CHECK ONSITE EXISTING SANITARY CONNECTION INVERT LEVEL TO ENSURE THAT SUFFICIENT FALL CAN BE INCORPORATED IN THE DRAINS WITHIN THE SITE.

* THE INDIVIDUAL DISCHARGE PIPE FROM THE TOPMOST FIXTURE ONLY MAY CONNECT WITHOUT SEPARATE VENTING TO THE DISCHARGE STACK VENT BUT MUST NOT EXCEED 3.5M FOR 32 TO 65MM PIPE.

* IN SUSPENDED TIMBER FLOORS ALWAYS RUN THE WASTE PIPES IN THE SAME DIRECTION AS THE JOISTS. LARGE HOLES MUST NOT BE DRILLED THROUGH JOISTS UNLESS THEY ARE SPECIFICALLY DRSIGNED AND APPROVED.

* MINIMUM GRADIENT OF DISCHARGE

A) 1:40 FOR PIPES 65MM DIAMETER AND UNDER

B) 1:60 FOR PIPES 100MM DISMETER AND UNDER

D) ALL PIPE(65/100MM DIA) UNDER SLAB TO BE MIN 1:60

* WATER SUPPLY: COLD/HOT WATER - CROSS LINKED POLYETHYLENE(PE-X) PIPE TO COMPLY WITH AS/NZS 2492.

* STORMWATER RECYCLE: NON/PORTABLE WATER - CROSS LINKED POLYETHYLENE(PE-X) PIPE TO COMPLY WITH AS/NZS 2492.

* GAS PIPES: MICROCOMPOSITE PIPE -POLYETHYLENE/ALUMINUM PIPE TO COMPLY WITH AS/NZS 4176

* HOT WATER SUPPLY UNIT: CYLINDER -WATER HEATER CYLINDER HOT WATER TEMPERATURES

TO COMLY WITH GZ

LOAD BEARING WALL

S/B

SOLID BLOCKING, AT MID-SPAN IF OVER 2.5M, FIX BLOCKING WITH 2/100 X 3.75 NAILS OR 4/75 X 3.15 NAILS EACH END. FIXINGS TO BE HOT-DIP GALVANIZED MIN, STAINLESS STEEL FIXINGS TO BE SUPPLIED WHERE IN EXPOSE TO WEATHER

ALL BEAMS REFER TO ENGINEER DESIGN

INTERIOR WET AREA FLOOR FRAMING: 19MM H3.2 PLYWOOD SUBSTRADE ON 240 X 45 H1.2 JOIST@MAX. 400CRS WITH SOLID NOG @ 400CRS. EXCEPT OTHER STATE ON PLAN.

FLOOR AREA TO BE INSULATED BY R2.2 INSULATION

2/240 X 45MM DOUBLE JOIST

MOD

FIRST FLOOR JOIST PLAN

JOIST NOTES:


HOLES DRILLED IN FLOOR JOISTS OTHER THAN CANTILEVERED JOISTS SHALL BE:

19/07/2024

(A) WITHIN THE MIDDLE THIRD OF THE DEPTH OF THE JOISTS, (B) NO MORE THAN 3 TIMES THE DEPTH OF THE JOIST FROM THE FACE OF A SUPPORT (REFER FIG. 7.8(A) NZS 3604:2011)

WHERE COMPLIANCE WITH NZS 3604:2011 CANNOT BE ACHIEVED, USE 'THRU JOIST' OR LUMBERLOK FLOOR JOIST STIFFENER PROPRIETARY SYSTEM, INSTALLED TO MANUFACTURER'S INSTRUCTIONS.

- DOUBLE JOISTS ARE TO BE PLACED UNDER ALL LOAD BEARING WALLS THAT RUN PARALLEL TO JOISTS. (FOR NON-LOAD BEARING WALLS SOLID BLOCKING BETWEEN JOISTS AT 1200 CRS. MAX. MAY BE USED. REFER NZS 3604:2011 7.1.3.5
- SOLID BLOCKING TO BE FIXED UNDER ALL WALLS RUNNING PERPENDICULAR TO JOISTS AND AT MID SPAN WHERE SPANS EXCEED
- ALL BEAM LENGTH NOTED ARE DESIGN SPANS AND NOT TO BE USED AS BEAM LENGTH. CONFIRM LENGTH ON SITE PRIOR TO FABRICATION. NOTIFY THE STRUCTURAL ENGINEER IF ACTURAL LENGTH IS DIFFERENT WITH DESIGN LENGTH.
- ALL FLOOR JOISTS SIZE AND SPACING ARE REFER TO STRUCTURAL ENGINEER DESIGN
- FLOOR INSULATION: R2.2 INSULATION BATT SUPPLIED TO CAVITY OF JOIST IN GARAGE, ENTRY AND PATIO(IF ANY)

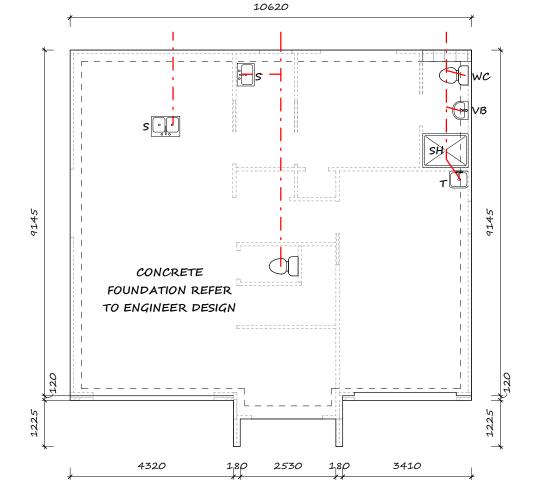

FOUNDATION PLAN

FOUNDATION & JOISTS PLAN

THIS PLAN TO BE READ IN CONJUNCTION WITH ENGINEERS DRAWINGS





THIS DOCUMENT AND THE COPYRIGHT IN THIS DOCUMENT REMAIN THE PROPERTY OF ACG	ISSUI
ARCHITECTURE LTD.	BC 1
1 SILVEREYE ROAD, HOBSENVILLE, AUCKLAND	100 1
EMAIL: ACCARCILIZATIONAL COM	

SHEET NAME: FOUNDATION&JOIST PLAN

19/07/2024

Page 9 of 30 Building Consent BCO10382663 Approved by Auckland Council

MEDIUM WIND ZONE

- * ROOF: 18.5° & 15° STYLELINE COLORSTEEL ROOFING OR SIMILAR WITH VARYING OVERHANGS OVER SELECTED ROOF UNDERLAY ON 70 x 45mm PURLINS AT 900mm CTRS ON APPROVED TRUSSES (AS PER MANUFACTURER SPECS)
- * TRUSS: TO BE DESIGNED AND APPROVED BY QUALIFIED TRUSS MANUFACTURER ABLE TO ISSUE A PRODUCER STATEMENT(PS1) PRIOR BUILDING CONSENT APPROVAL
- *ALL ROOF PENETRATION SHALL BE FLASHED AS PER PRODUCT SPECS
- *SELECTED BUILDING WRAP FOR AIR BARRIER TO GABLES
- * THE TRUSS SYSTEM SHALL INCLUDES ROOF SPACE BRACING IN ACCORDANCE WITH NZS 3604\;2011

* PAINTED 4.5mm HARDIEFLEX SOFFIT LINNING WITH PVC JOINTERS THROUGHOUT

LEGEND:

DP - 80mm DIA uPVC DOWN PIPE (50m2 MAX) DS - 80mm DOWN PIPE WITH SPREADER (25m2

SPECIFIC NOTE:

NOTE 1:


PAIR OF CROSSED LUMBERLOK 0.6 x 27mm STEEL STRIP BRACES, FIXED USING 5/75mm x 3.15mm DIA FLAT HEAD NAILS AT EACH END & 1/75mm x 3.15mm NAIL AT EACH CROSSING


UPPER ROOF AREA: 111.80m2 (MEASURED IN PLAN)

- 1 x HIP/VALLEY BRACE / 50m2 MIN
- 3 × BRACE REQUIRED
- 3 × PROVIDED

LOWER ROOF AREA: 22.80m2 (MEASURED IN PLAN)

- 1 x HIP/VALLEY BRACE / 50m2 MIN
- 1 x BRACE REQUIRED
- 1 × PROVIDED

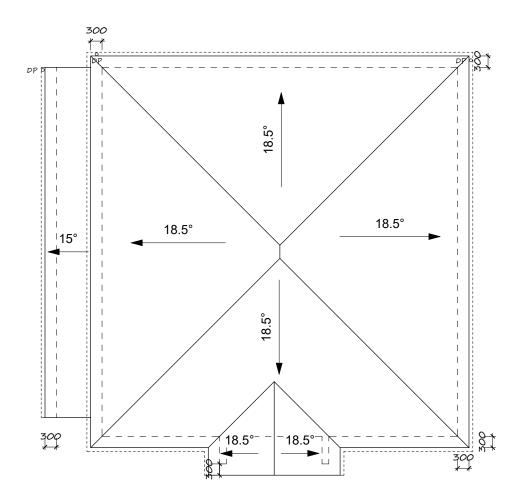

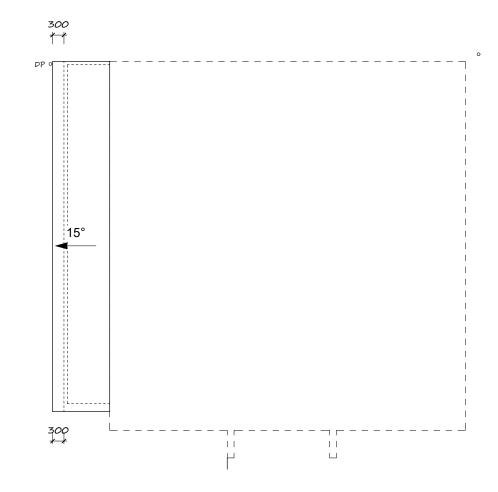





THIS DOCUMENT AND THE COPYRIGHT IN THIS DOCUMENT REMAIN THE PROPERTY OF ACG ARCHITECTURE LTD.
SILVEDEYE DOAD HORSENVILLE ALICULANI

ISSUE:	DATE:	DOCUMENTS VERSION:
BC 1	04/24	BUILDING CONSENT ISSUE

PROPOSED NEW DWELLING AT 53 HELVETIA ROAD, PUKEKOHE, AUCKLAND LOT 1, DP 50263


SHEET NAME: ROOF PLAN

DRAWN BY:	PROJECT NO. 23/2223
DESIGNED BY: H.C	DATE: 01/05/2024
DRAWN SCALE	

SHEET NO: 2.04


Page 10 of 30 Building Consent BCO10382663 Approved by Auckland Council

NORTH&EAST ELEVATION	RISK FACTOR		
RISK FACTOR	LEVEL	SCORE	
WIND ZONE	MEDIUM	0	
NUMBER OF STOREY	HIGH	2	
ROOF/WALL INTERSECTION	VERY HIGH	5	
EAVES WIDTH	VERY HIGH	5	
ENVELOPE COMPLEXITY	MEDIUM	1	
DECK	LOW	0	
TOTAL RISKY SCORE		13	

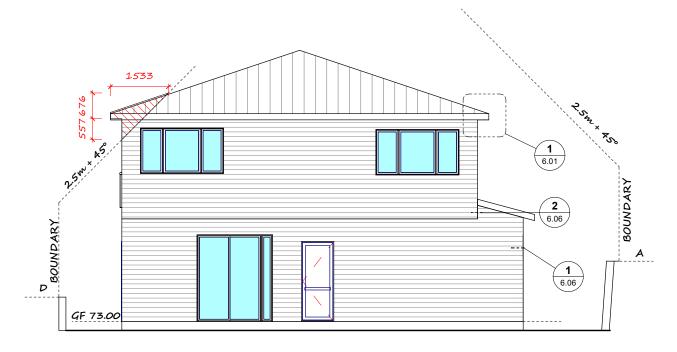

ELEVATION N&E

SOUTH&EAST ELEVATION	RISK FACTOR	
RISK FACTOR	LEVEL	SCORE
WIND ZONE	MEDIUM	0
NUMBER OF STOREY	HIGH	2
ROOF/WALL INTERSECTION	VERY HIGH	5
EAVES WIDTH	VERY HIGH	5
ENVELOPE COMPLEXITY	MEDIUM	1
DECK	LOW	0
TOTAL RISKY SCORE		13

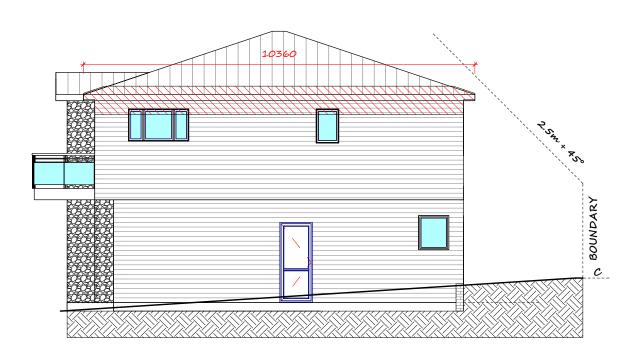

ELEVATION S&E

GENERAL NOTES:

ALL PROPRIETARY PRODUCTS TO BE INSTALLED ACCORDACE WITH THE MANUFACTURERS INSTRUCTIONS, UNLESS SPECIFIED OTHERWISE.

19/07/2024

ALL DOORS AND WINDOWS SIZE TO BE MEASURED ON SITE PRIOR TO MANUFACTURE

SAFETY GLASS IN ACCORDANCE WITH NZS 4223

ALL GLAZING EXCEPT GARAGE TO BE DOUBLE GLAZED AND HAVE AN R-VALUE OF 0.46 OR BETTER

MINIMUM HEIGHT OF FINISHED CONCRETE SLAB ON GROUND FLOOR ABOVE ADJOINING FINISHING GROUND LEVEL TO BE:

- * MASONRY VENEER: 100MM TO PERMANENT PAVING; 150MM TO UNPROTECTED GROUND.
- * ALL CLADDING: 150MM TO PERMANENT PAVING; 225 TO UNPROTECTED GROUND

EXTERIOR JOINERY HEIGHT:

- * GROUND FLOOR: 2300 FROM FFL TO UNDER
- * FIRST FLOOR: 2100 FROM FFL TO UNDER SIDE OF LINTEL

LEGEND:

ROOFING

-COLORSTEEL LONGRUN STEEL



-TIMBER BEVEL-BACK WEATHER BOARD



TIMBER VERTICAL WEATHERBOARD

H*W

OPEN EDGE



WINDOW OPEN EDGE NOTE: RESTRICTORS SUPPLIED TO ALL OENING PANEL

DENS PRACTIFICATION OF THE PROPERTY OF THE PRO	T D
www.dbh.govt.nz	1
O/MO COSTELLOS	

S DOCUMENT AND THE COPYRIGHT IN TH CUMENT REMAIN THE PROPERTY OF ACC CHITECTURE LTD.
UNEDEXE DOAD HOSSENNULE AUGULA

ISSUE:	DATE:	DOCUMENTS VERSION:
BC 1	04/24	BUILDING CONSENT ISSUE

Page 11 of 30 Building Consent BCO10382663 Approved by Auckland Council

NORTH&WEST ELEVATION	RISK FACTOR	
RISK FACTOR	LEVEL	SCORE
WIND ZONE	MEDIUM	0
NUMBER OF STOREY	HIGH	2
ROOF/WALL INTERSECTION	VERY HIGH	5
EAVES WIDTH	VERY HIGH	5
ENVELOPE COMPLEXITY	MEDIUM	1
DECK	LOW	0
TOTAL RISKY SCORE		13



ELEVATION N&W

SOUTH&WEST ELEVATION	RISK FACTOR	
RISK FACTOR	LEVEL	SCORE
WIND ZONE	MEDIUM	0
NUMBER OF STOREY	HIGH	2
ROOF/WALL INTERSECTION	VERY HIGH	5
EAVES WIDTH	VERY HIGH	5
ENVELOPE COMPLEXITY	MEDIUM	1
DECK	LOW	0
TOTAL RISKY SCORE		13



19/07/2024

GENERAL NOTES:

ALL PROPRIETARY PRODUCTS TO BE INSTALLED ACCORDACE WITH THE MANUFACTURERS INSTRUCTIONS, UNLESS SPECIFIED OTHERWISE.

ALL DOORS AND WINDOWS SIZE TO BE MEASURED ON SITE PRIOR TO MANUFACTURE

SAFETY GLASS IN ACCORDANCE WITH NZS 4223

ALL GLAZING EXCEPT GARAGE TO BE DOUBLE GLAZED AND HAVE AN R-VALUE OF 0.46 OR

MINIMUM HEIGHT OF FINISHED CONCRETE SLAB ON GROUND FLOOR ABOVE ADJOINING FINISHING GROUND LEVEL TO BE:

- * MASONRY VENEER: 100MM TO PERMANENT PAVING: 150MM TO UNPROTECTED GROUND.
- * ALL CLADDING: 150MM TO PERMANENT PAVING; 225 TO UNPROTECTED GROUND

EXTERIOR JOINERY HEIGHT:

- * GROUND FLOOR: 2300 FROM FFL TO UNDER SIDE OF LINTEL
- * FIRST FLOOR: 2100 FROM FFL TO UNDER SIDE OF LINTEL

LEGEND:

-COLORSTEEL LONGRUN STEEL ROOFING

-TIMBER BEVEL-BACK WEATHER BOARD

TIMBER VERTICAL WEATHERBOARD

> H*W OPEN EDGE

WINDOW OPEN EDGE NOTE: RESTRICTORS SUPPLIED TO ALL OENING PANEL






IS DOCUMENT AND THE COPYRIGHT IN TH CUMENT REMAIN THE PROPERTY OF ACG CHITECTURE LTD.
SILVEREYE ROAD, HOBSENVILLE, AUCKLA

HE COPYRIGHT IN THIS E PROPERTY OF ACG	ISSUE:	DATE:	DOCUMENTS VERSION
	BC 1	04/24	BUILDING CONSENT ISSU
3SENVILLE, AUCKLAND IZ@HOTMAIL.COM			



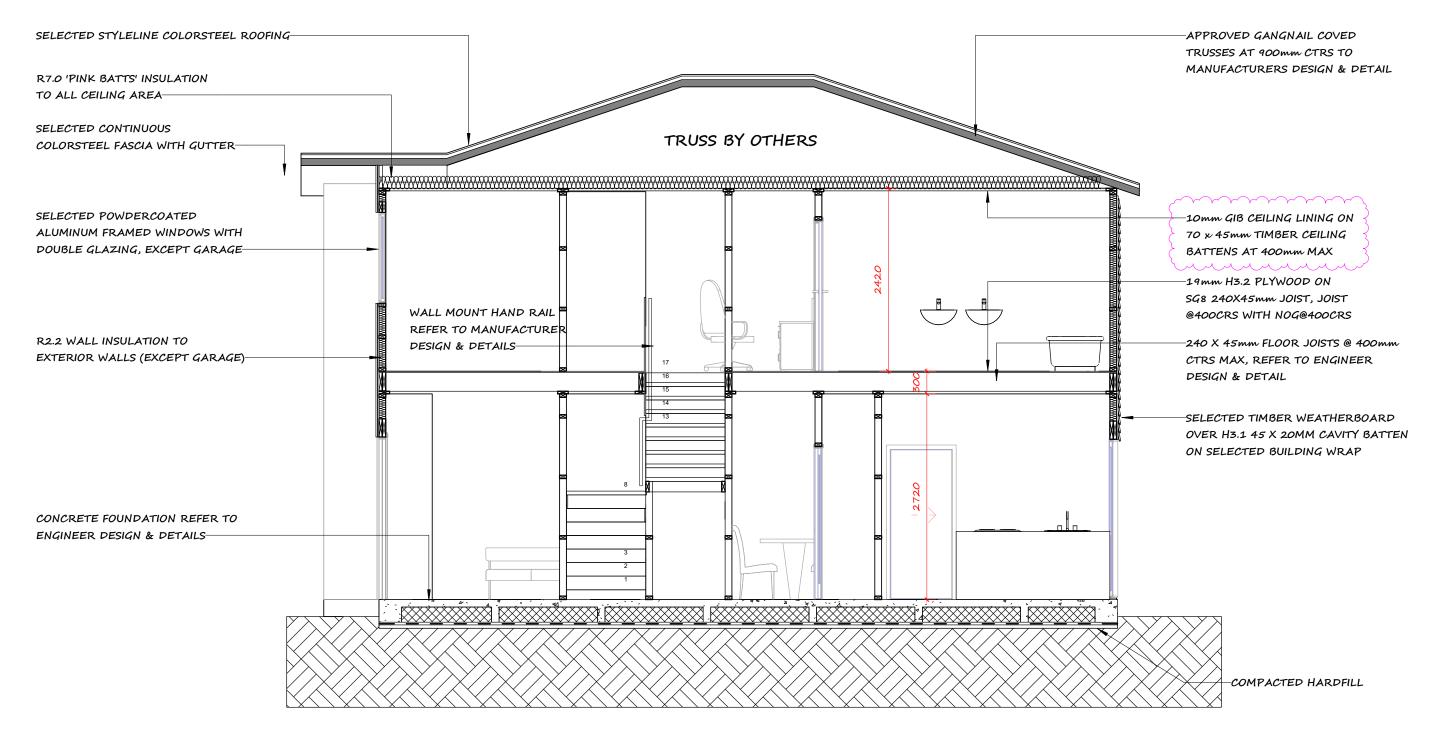

SECTION A-A



_		-
•	HILDING PRACTI	TI D A
1	www.dbh.govt.nz	1

THIS DOCUMENT AND THE COPYRIGHT IN THIS DOCUMENT REMAIN THE PROPERTY OF ACG ARCHITECTURE LTD.

1 SILVEREYE ROAD, HOBSENVILLE, AUCKLAND EMAIL: ACGARCHNZ®HOTMAIL.COM

ISSUE: DATE: DOCUMENTS VERSION:

RFI A 06/22 BC RFI - CLOUDED AREAS

PROJECT: PROPOSED NEW DWELLING AT

53 HELVETIA ROAD, PUKEKOHE, AUCKLAND

LOT 1, DP 50263

SHEET NAME: SECTION A


PRAWN BY: H.C PROJECT NO. 23/2223 S

PESIGNED BY: H.C PATE: 12/01/22

PRAWN SCALE: 1:50

SHEET NO: REV A



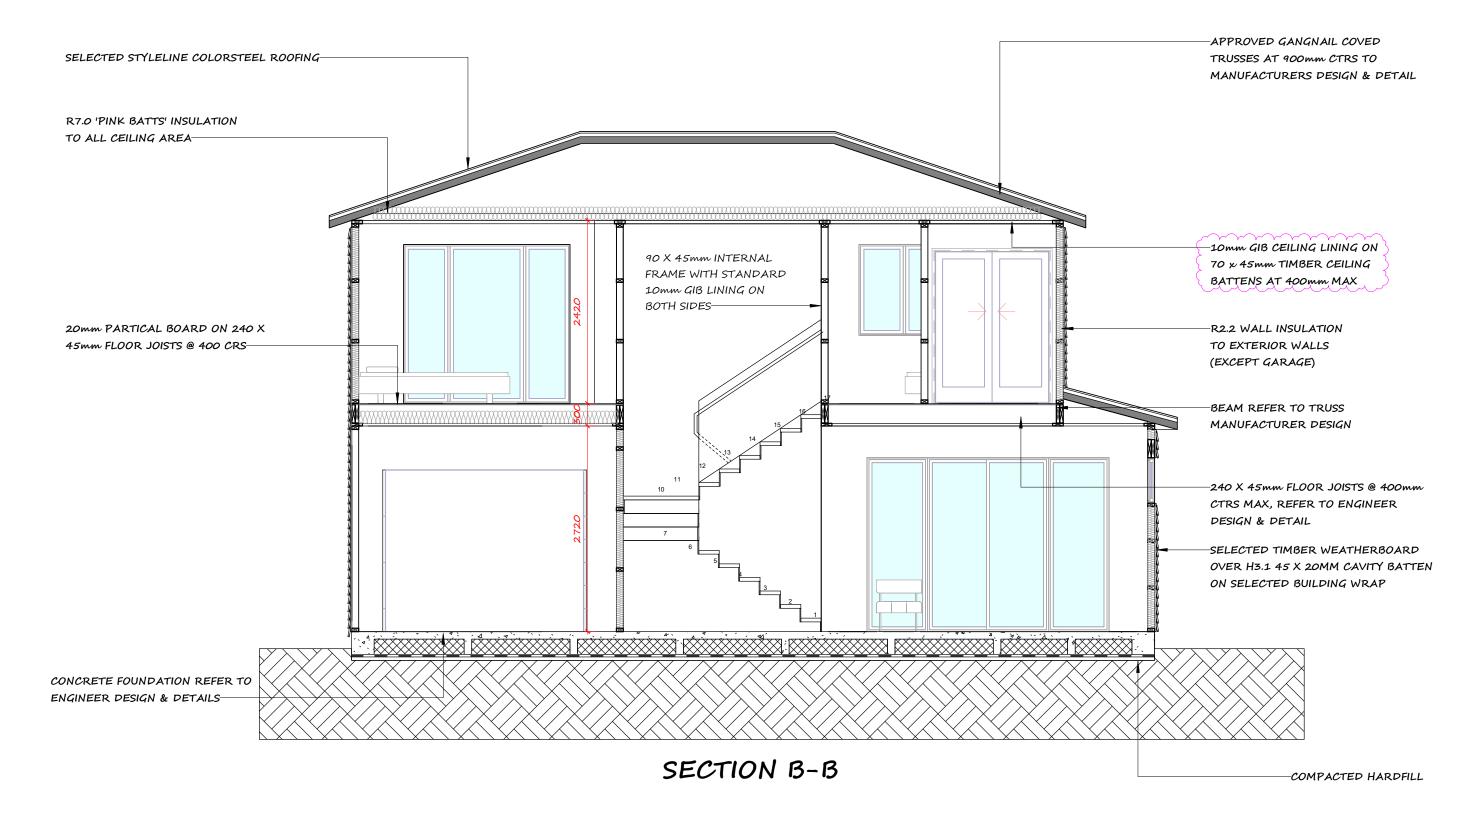

ACG ARCHITECTURE LTD	Oling LICENSED
----------------------	----------------

)	DENOR PRAGRAMENTE	
	www.dbh.govt.nz	

THIS DOCUMENT AND THE COPYRIGHT IN THIS DOCUMENT REMAIN THE PROPERTY OF ACG ARCHITECTURE LTD.
1 SILVEREYE ROAD, HOBSENVILLE, AUCKLAN

ISSUE: DATE: DOCUMENTS VERSION:

RFI A 06/22 BC RFI - CLOUDED AREAS


PROJECT: PROPOSED NEW DWELLING AT
53 HELVETIA ROAD, PUKEKOHE, AUCKLAND
LOT 1, DP 50263

SHEET NAME: SECTION B

PRAWN BY: H.C PROJECT NO. 23/2223 S. PESIGNED BY: H.C PATE: 05/06/24

DRAWN SCALE:

SHEET NO: REV A

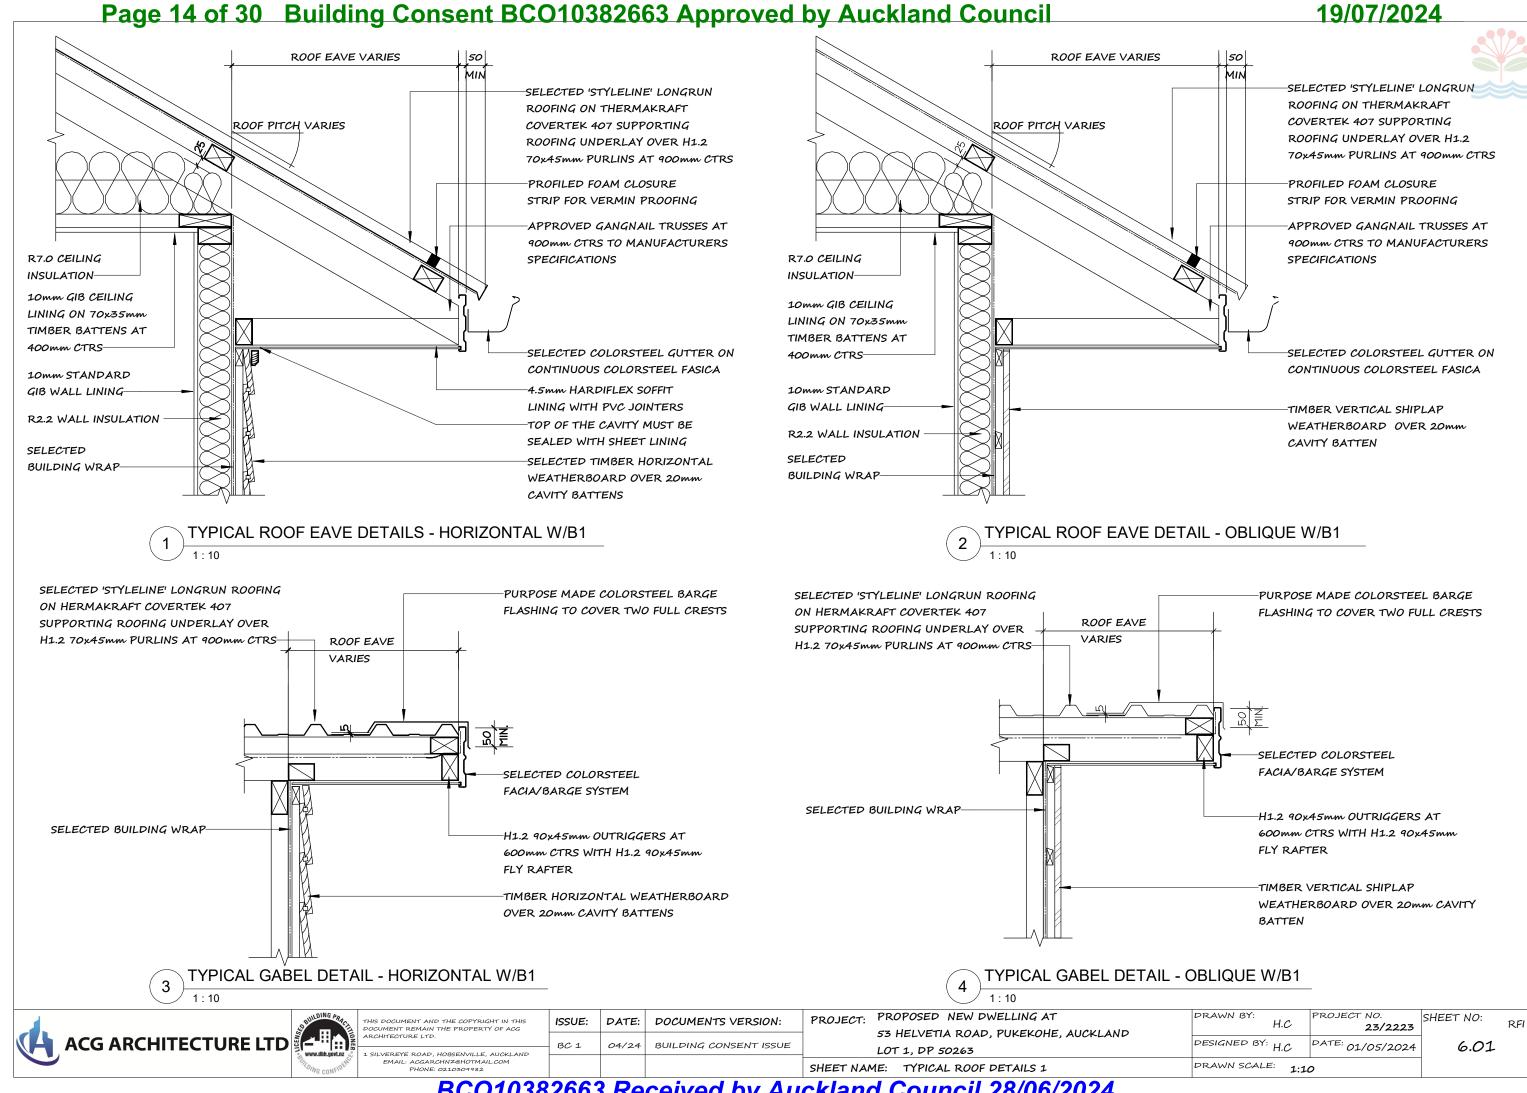



ROLL TOP RIDGE

TURN DOWN TO SUIT ROOFING


ROOF STRUCTR

FLASHING-

PROFILE-

15mm PLYWOOD SUPPORT

FOR VALLEY GUTTER

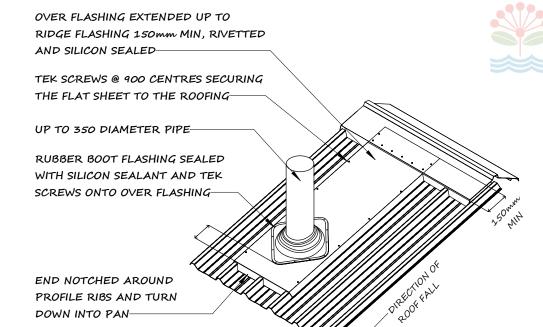

19/07/2024

1 TYPICAL ROOF VALLEY DETAIL
1:10

BETWEEN ROOFING

LONGRUN ROOFING-

VALLEY RAFTER-

ROOFING WRAP CONTINUOUS

UNDER GUTTER IF COPPER
BASED TREATMENTASRE USED—

2 TYPICAL ROOF RIDGE DETAIL1

STOPEND


SCREW FIXING

COMPRESSIBLE SEAL


SOFT EDGE DRESSED

TO SUIT PROFILE

3 TYPICAL PIPE THROUGH STEEL ROOF DETAILS1

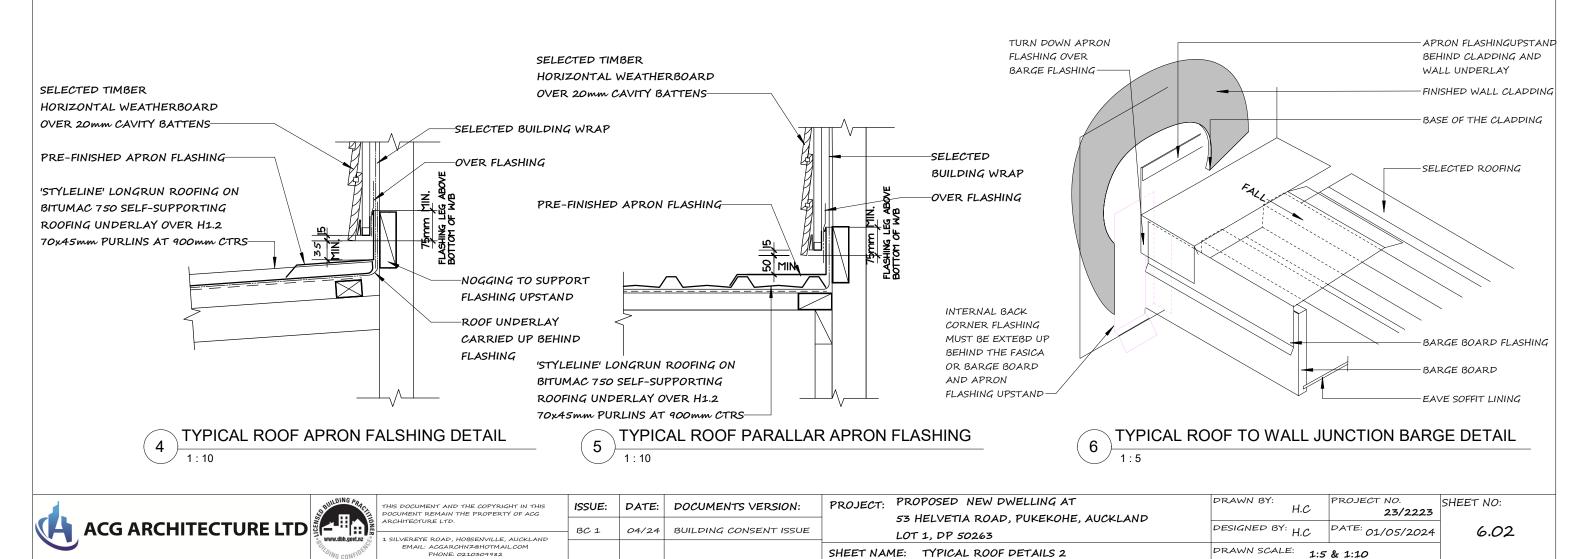



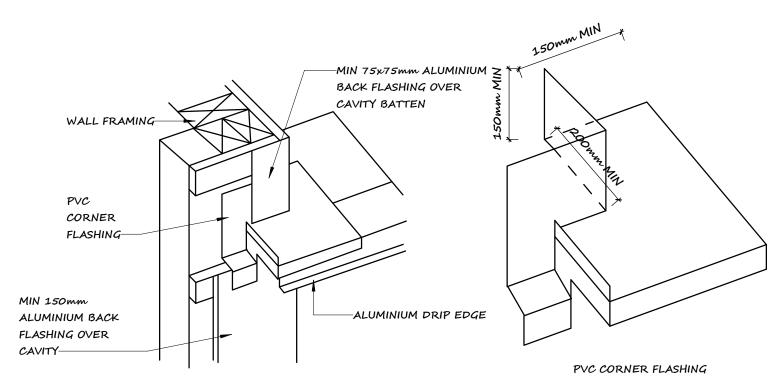

TYPICAL ROOF BARGE TO WALL DETAILS



	BUILDING PRACA	
)	Www.dbh.govt.nz	_
	SUITO INC. CONFIDENCE	


OCUMENT AND THE COPYRIGHT IN THIS MENT REMAIN THE PROPERTY OF ACG	ISSUE:	DATE:	DOCUMENTS VERSION:
TECTURE LTD.	BC 1	04/24	BUILDING CONSENT ISSUE
EREYE ROAD, HOBSENVILLE, AUCKLAND	100 1	01/21	1501221119 501152111 15501
EMAIL: ACGARCHNZ@HOTMAIL.COM			

PROPOSED NEW DWELLING AT 53 HELVETIA ROAD, PUKEKOHE, AUCKLAND LOT 1, DP 50263


SHEET NAME: TYPICAL ROOF DETAILS 3

DRAWN BY: SHEET NO: PROJECT NO. H.C23/2223 DESIGNED BY: H.C DATE: 01/05/2024 DRAWN SCALE: N.T.S


6.03

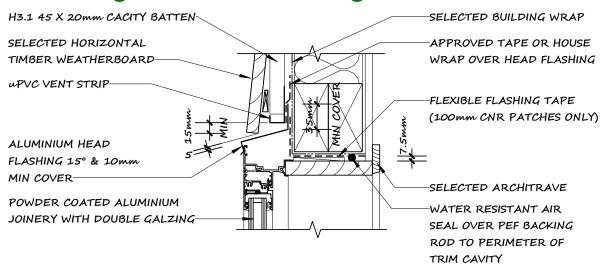


TYPICAL W/B WINDOW HEAD DETAIL1

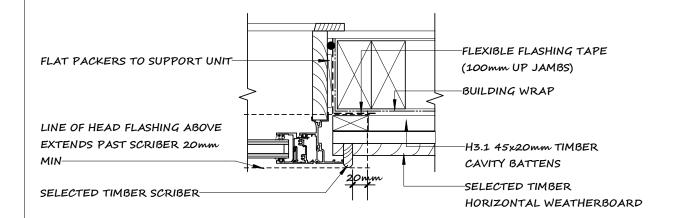


TYPICAL W/B WINDOW JAMB DETAIL1

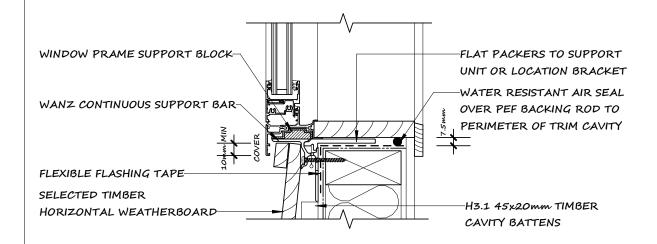



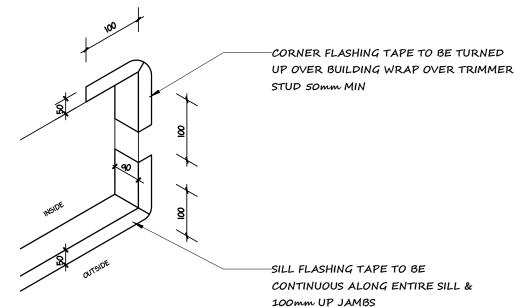

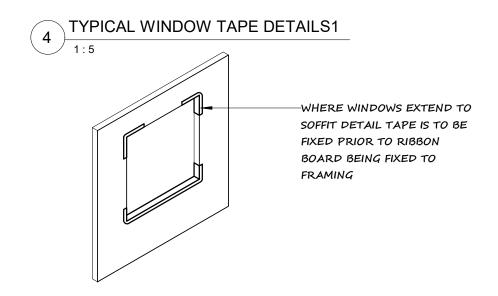

TURN-UP MEMBRANE 100mm MIN. AT TRIMMER STUDS-TAPERED REVEAL TO SUIT-AIR SEAL-WINDOW FRAME SUITABLE SILL MEMBRANE WANZ SUPPORT BAR, PRE-FILL FIXING HOLES FLOOR STRUCTURAL-

TYPICAL WINDOW TAPE LOCATION DETAILS1

TYPICAL WINDOW SUPPORT BAR DETAIL1





1 00	THIS DOCUMENT AND THE COPYRIGHT IN THIS DOCUMENT REMAIN THE PROPERTY OF ACG ARCHITECTURE LTD.	ISSUE:	DATE:	DOCUMENTS VERSION:	PROJECT: F	ROPOSED NEW DWELLING AT
			4/24 BUILDING CONSENT ISSUE	5	3 HELVETIA ROAD, PUKEKOHE, A	
ER og	1 SILVEREYE ROAD, HOBSENVILLE, AUCKLAND	BC 1 04		L	OT 1, DP 50263	
2.	EMAIL: ACGARCHNZ@HOTMAIL.COM PHONE: 0210309982				SHEET NAME	TYPICAL WINDOW DETAILS 1


CT: PROPOSED NEW DWELLING AT 53 HELVETIA ROAD, PUKEKOHE, AUCKLAND LOT 1, DP 50263

DRAWN BY PROJECT NO. 23/2223 DATE: 01/05/2024


WITH SILICON SEALANT

6.04


SHEET NO:

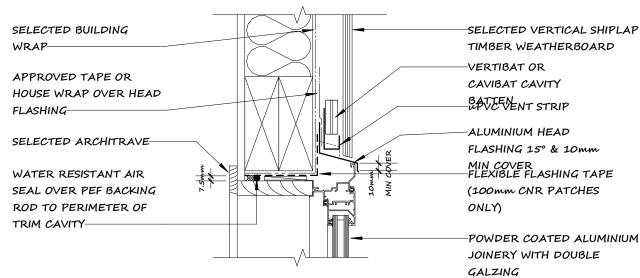

TYPICAL VERTICAL W/B WINDOW HEAD DETAIL

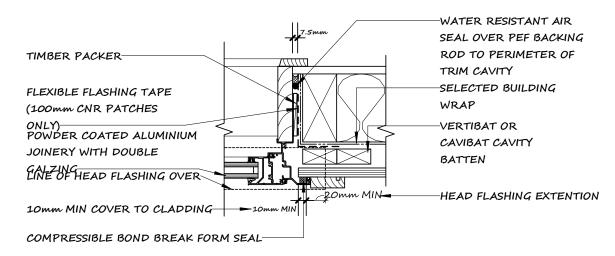



TYPICAL VERTICAL W/B WINDOW JAMB DETAIL

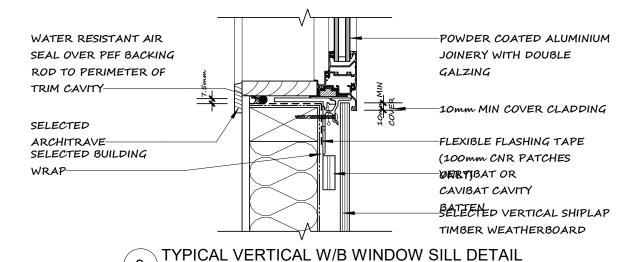

SELECTED 70 SERIES BRICK VENEER BEYOND BUILDING WRAP APPROVED TAPE OR SELECTED TIMBER HOUSE WRAP OVER HEAD CLADDING OVER 20mm FLASHING-CAVITY FLEXIBLE FLASHING TAPE ALUMINIUM HEAD FLASHING (100mm CNR PATCHES ONLY)-HEAD SEAL WATER RESISTANT AIR SEAL OVER PEF BACKING POWDER COATED ALUMINIUM ROD TO PERIMETER OF JOINERY WITH DOUBLE TRIM CAVITY GALZING

TYPICAL BRICK VENEER WINOW HEAD

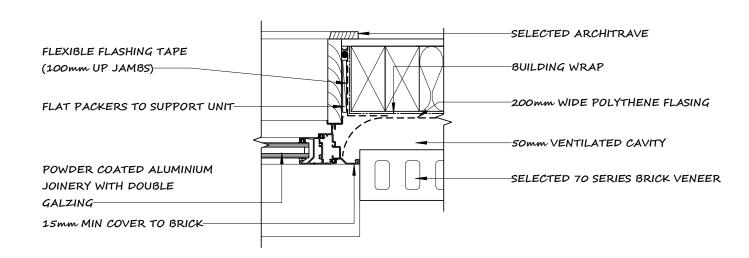

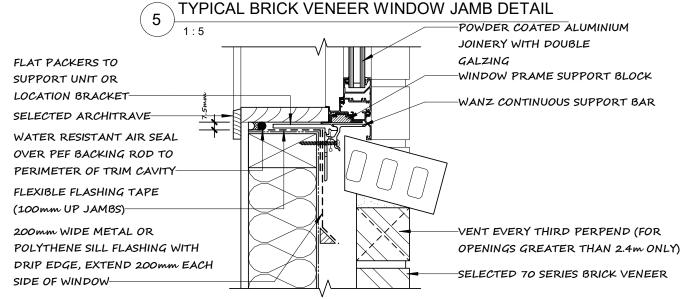

TYPICAL BRICK VENEER WINDOW SILL DETAIL






HIS POCUMENT AND THE COPYRIGHT IN THIS	ISSUE:	DATE.	DOCUMENTS VERSION:
OCUMENT REMAIN THE PROPERTY OF ACG RCHITECTURE LTD.			
SILVEREYE ROAD, HOBSENVILLE, AUCKLAND	BC 1	04/24	BUILDING CONSENT ISSU
EMAIL: ACGARCHNZ@HOTMAIL.COM			

PROJECT: PROPOSED NEW DWELLING AT 53 HELVETIA ROAD, PUKEKOHE, AUCKLAND LOT 1, DP 50263


SHEET NAME: TYPICAL WINDOW DETAILS 2

DRAWN BY PROJECT NO. SHEET NO: 23/2223 DATE: 01/05/2024 DRAWN SCALE:


6.05

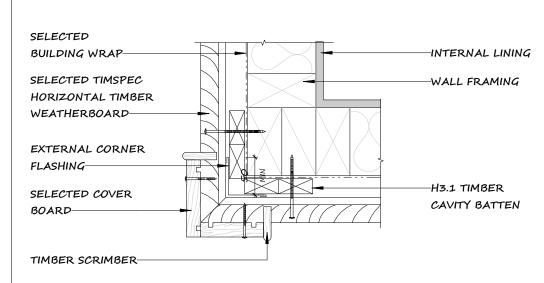


TYPICAL W/B EXTERNAL CORNER DETAIL (BOXED)1

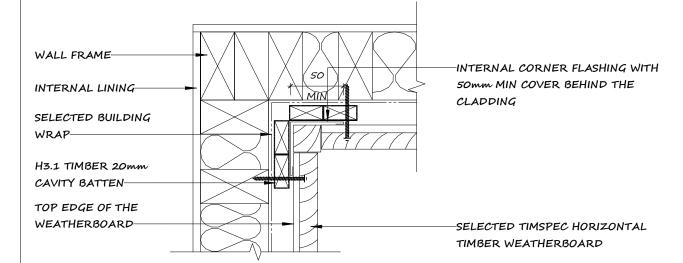


TYPICAL W/B INTERNAL CORNER DETAIL1

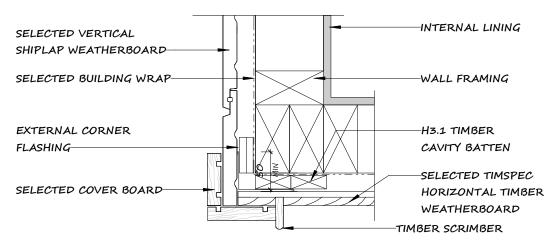

TIPICAL EXTERNAL CORNER DETAIL - V/H WEATHERBOARD

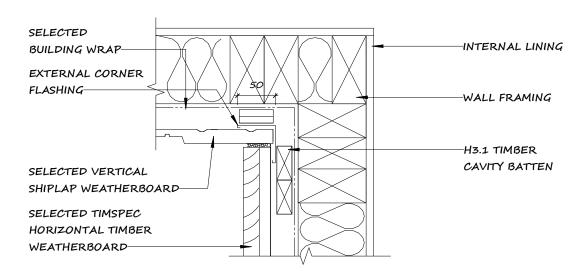

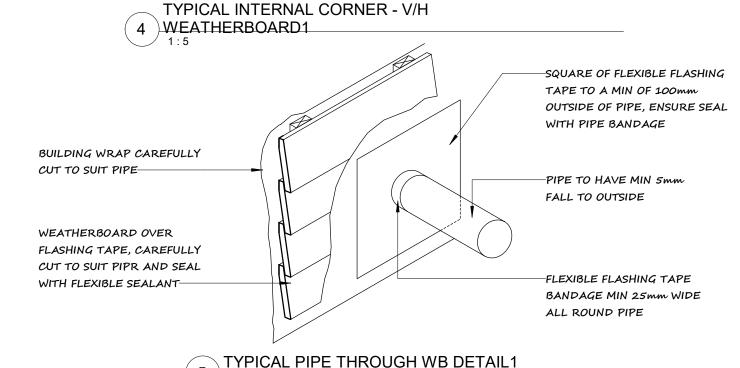

	,	—SELECTED CLADDING
CAVITY BATTEN		— FLASHING TAPE OVER HEAD FLASHING
SELECTED THERMAKRAFT		
WALL UNDERLAY		— HEAD FLASHING WITH 15° FALL, STOP ENDED
JAMES HARDIE® UPVC VENT		AND EXTENDED TO EDGE OF VENT TOP AND
STRIP WITH 1000Mm OF	**************************************	EXTENDED INTO THE SIDES
OPENING PER LINEAL METRE		
		–MANROSE WEATHERPROOF COWL
		PROPRIETARY EXTRACT VENTILATION
SOLID BLOCKING AROUND		HOODED TYPE
PIPE PENETRATION———————		
		-FLASHING TAPE AROUND PIPE AND ONTO
		BUILDING PAPER(100mm LAP TO
		BUILDING PAPER AND 25mm MIN TO PIPE)

TYPICAL VENTILATION DETAIL1





THIS DOCUMENT AND THE COPYRIGHT IN THIS DOCUMENT REMAIN THE PROPERTY OF ACG	ISSUE:	DATE:	DOCUMENTS VERSION:
ARCHITECTURE LTD.	BC 1	04/24	BUILDING CONSENT ISSU
1 SILVEREYE ROAD, HOBSENVILLE, AUCKLAND	.50 -	0 17 2 1	50.22 550
EMAIL: ACGARCHNZ@HOTMAIL.COM			


PROJECT: PROPOSED NEW DWELLING AT

53 HELVETIA ROAD, PUKEKOHE, AUCKLAND LOT 1, DP 50263

DRAWN BY PROJECT NO. SHEET NO: H.C23/2223 DATE: 01/05/2024


6.06


1:5 & 1:10

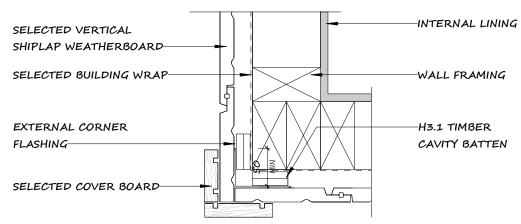

TYPICAL EXTERNAL CORNER DETAIL - VERTICAL


1 W/B

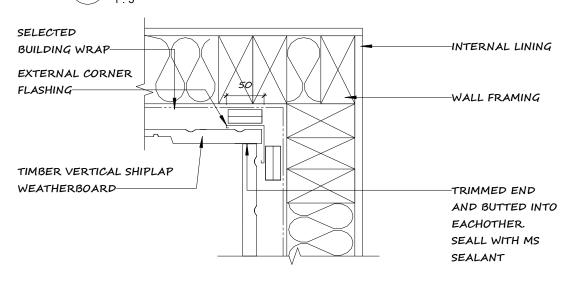

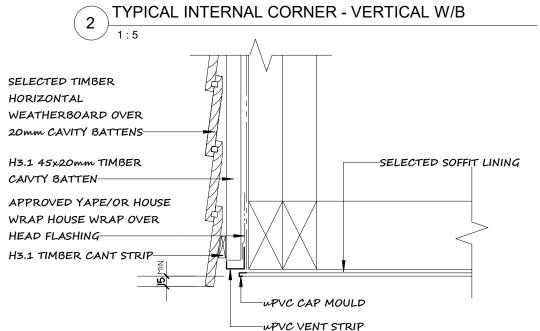

3 TYPICAL SOFFIT EDGE DETAIL1

ACG ARCHITECTURE LTD

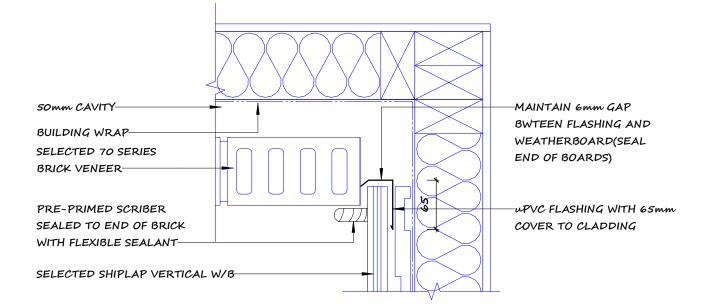



TYPICAL INTERNAL CORNER-BRICK&WB


PROPOSED NEW DWELLING AT DRAWN BY PROJECT: PROJECT NO. SHEET NO: DATE: **DOCUMENTS VERSION:** ISSUE: 23/2223 53 HELVETIA ROAD, PUKEKOHE, AUCKLAND DATE: 01/05/2024 BUILDING CONSENT ISSUE 6.07 LOT 1, DP 50263 SILVEREYE ROAD, HOBSENVILLE, AUCKLAND EMAIL: ACGARCHNZ@HOTMAIL.COM SHEET NAME: TYPICAL CLADDING DETAILS 2


Page 21 of 30 Building Consent BCO10382663 Approved by Auckland Council 19/07/2024 MIN CLEARANCE BETWEEN THE BOTTOM OF CLADDING AND DRIVEWAY AT BRICK VENEER SELECTED 70 SERIES BRICK GARAGE DOOR OPENINGS-SELECTED BUILDING WRAP WALL VENEER OVER 50mm CAVITY. CLADDING BRICK TIES TO BE HOT INTERNAL WALL LINING-DIPPED GALV.AT 400mm CRS. HORIZONTAL AND DPC-20mm SET DOWN 400mm CRS VERT MAX CONCRETE FOUNDATION FOR GARAGE REFER TO ENGINEER DOOR-UNPAVED GROUND -MORTARED SLOPE DESIGN-WITH MIN 2 COATS FLINTCOTE **EWEEPHOLES** EVERY THIRD PERPEND EXTERIOR PAVING TYPICAL BRICK GARAGE OPENING DETAILS TYPICAL BRICK VENEER FOUNDATION DETAIL R2.2 WALL INSULATION-SELECTED VERTICAL SHIPLAP TIMBER WEATHERBOARD -H3.1 20mm CAVITY BATTEN INTERNAL LINING H1.2 90X45mm -BUILDING WEAP SELECTED BUILDING WRAP воттом 200mm POLYTHENE JAMB FLASHING -VERTIBAT OR CAVIBAT REFER TO ENGINEER CAVITY BATTEN DESIGN-UPVC VENT STRIP 50mm VENTILATION CAVITY R2.2 WALL INSULATION-SELECTED 70 SERIES BRIVK VENEER SELECTED HORIZONTAL TIMBER WEATHERBOARD INTERNAL LINING-H3.1 20mm CAVITY BATTEN H1.2 90X45mm TYPICAL BRICK VENEER GARAGE DOOR JAMB BUILDING WEAP BOTTOM PLATE CONCRETE FOUNDATION -DPC WPVC VENT STRIP REFER TO ENGINEER TYPICAL VERTICAL W/B FOUNDATION DETAIL DESIGN--50mm VENTILATION CAVITY BUILDING WRAP GARAGE WALL FRAMING BRICK TIE SELECTED 70 SERIES BRIVK VENEER GARAGE DOOR LINTEL OR STEEL STRUCTURAL NURAPLY 3P FLASHING OVER REFER TO ENGINEER BUILDING WRAP -125X75X10mm GALV BRICK LINTEL DESIGN-TYPICAL W/B FOUNDATION DETAIL TIMBER LINING-TYPICAL BRICK VENEER GARAGE DOOR HEAD PROPOSED NEW DWELLING AT DRAWN BY PROJECT NO. SHEET NO: PROJECT: **DOCUMENTS VERSION:** ISSUE: DATE: 23/2223 53 HELVETIA ROAD, PUKEKOHE, AUCKLAND ACG ARCHITECTURE LTD DATE: 01/05/2024 BUILDING CONSENT ISSUE 6.08 LOT 1, DP 50263 SILVEREYE ROAD, HOBSENVILLE, AUCKLAND EMAIL: ACGARCHNZ@HOTMAIL.COM SHEET NAME: TYPICAL FOUNDATION EDGE DETAILS

FLAT SOFFIT DETAIL

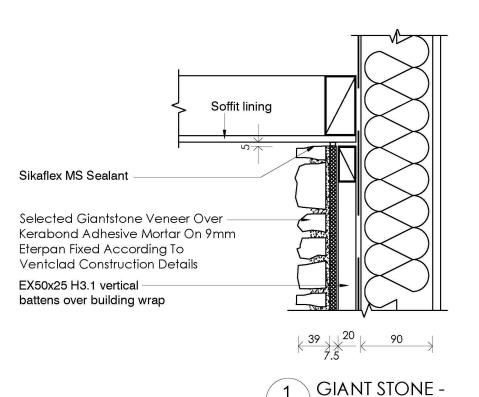

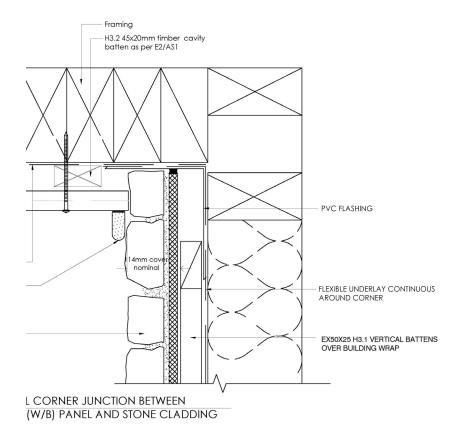

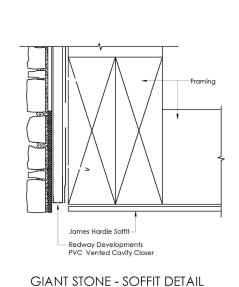

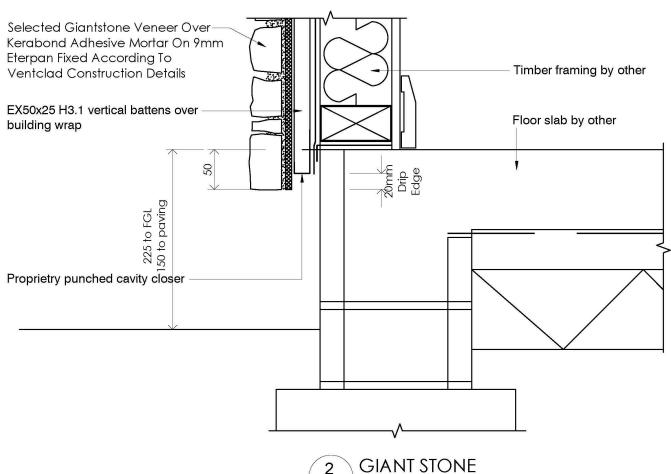

ACG ARCHITECTURE LTD

BASE DETAIL


1 SILVEREYE ROAD, HOBSENVILLE, AUCKLAND EMAIL: ACGARCHNZEHOTMAIL.COM PHONE: 0210309982


ISSUE:


DATE:


PROPOSED NEW DWELLING AT DRAWN BY: SHEET NO: PROJECT: PROJECT NO. H.C 23/2223 53 HELVETIA ROAD, PUKEKOHE, AUCKLAND DESIGNED BY: H.C DATE: 01/05/2024 BUILDING CONSENT ISSUE 6.09 LOT 1, DP 50263 SHEET NAME: TYPICAL CRAFT STONE DETAILS 1 DRAWN SCALE:

DOCUMENTS VERSION:

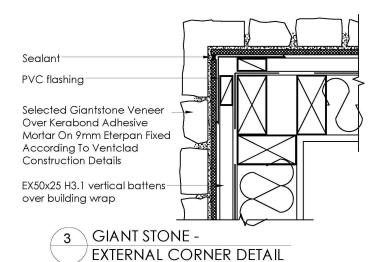

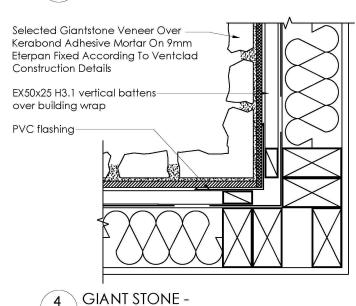

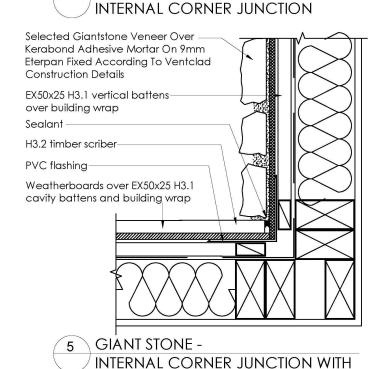

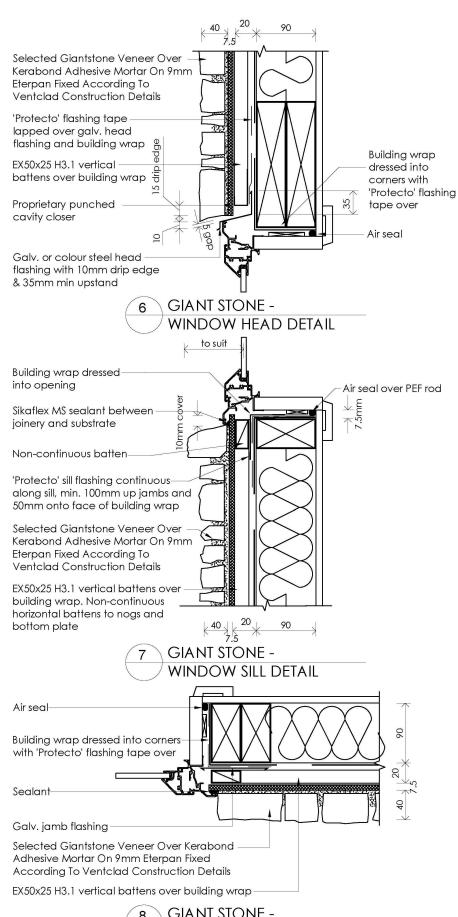







THIS DOCUMENT AND THE COPYRIGHT IN DOCUMENT REMAIN THE PROPERTY OF ARCHITECTURE LTD.
1 SILVEREYE ROAD, HOBSENVILLE, AUC

TIMBER WEATHERBOARD ON CAVITY

DATE: DOCUMENTS VERSION: ISSUE: BUILDING CONSENT ISSUE BC 1

PROPOSED NEW DWELLING AT PROJECT:

SHEET NAME: TYPICAL CRAFT STONE DETAILS 2


53 HELVETIA ROAD, PUKEKOHE, AUCKLAND LOT 1, DP 50263


DRAWN BY PROJECT NO. H.C23/2223 DESIGNED BY: H.C DATE: 01/05/2024 DRAWN SCALE:

6.10


SHEET NO:



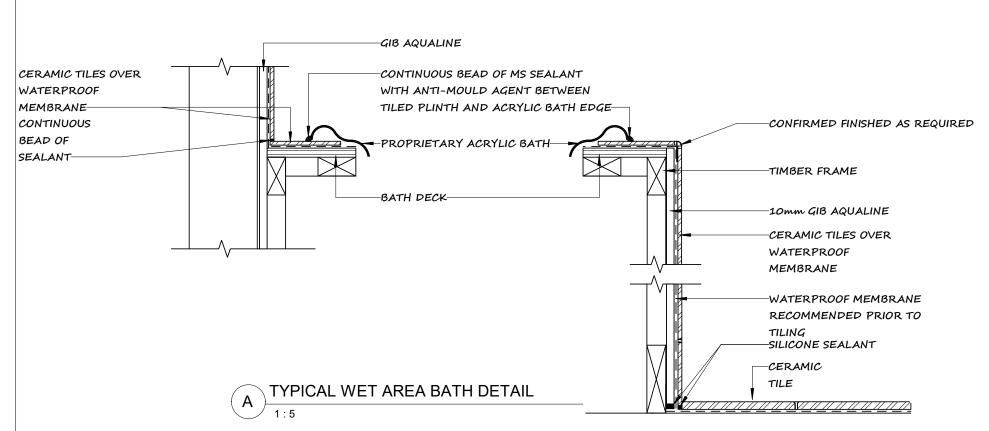


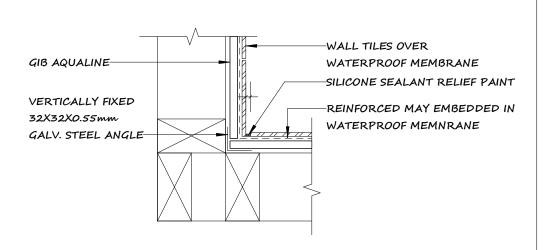


TYPICAL WET AREA TILE WALL INTERNAL CORNER

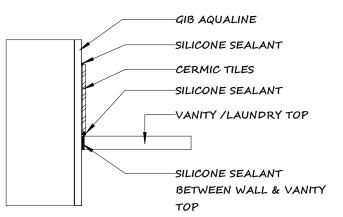

TYPICAL WET AREA VANITY TOP DETAIL

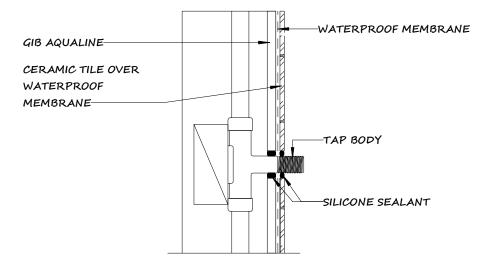

TYPICAL WET AREA PIPE THROUGH TILE WALL D DETAIL

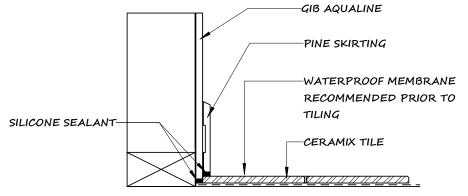

TYPICAL WET AREA TILE FLOOR WITH PINE SKIRT DETAIL



AND THE PROPERTY OF THE PROPER	7 5
Www.dbh.govt.nz	1


HIS DOCUMENT AND THE COPYRIGHT IN THIS OCUMENT REMAIN THE PROPERTY OF ACG	ISSUE:	DATE:	DOCUMENTS VERSION:
RCHITECTURE LTD.	BC 1	04/24	BUILDING CONSENT ISSU
SILVEREYE ROAD, HOBSENVILLE, AUCKLAND EMAIL: ACGARCHNZ@HOTMAIL.COM	.50 =	0 1, 2 1	50.22 114 001152111 1550

PROPOSED NEW DWELLING AT 53 HELVETIA ROAD, PUKEKOHE, AUCKLAND LOT 1, DP 50263

SHEET NAME: TYPICAL WET AREA DETAILS

DRAWN BY PROJECT NO. SHEET NO: H.C 23/2223 DATE: 01/05/2024 DRAWN SCALE: 1:5

6.11

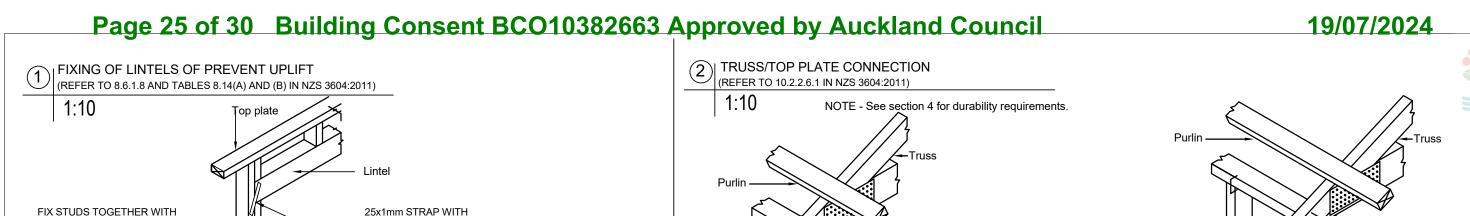

100X3.75mm NAILS @600crs

IMMEDIATELY UNDER THE

A-DOUBLING STUD

WIND ZONE


ROOF WEIGHT: LIGHT


TRUSS SPACING: 900crs.

LOADED DIMENSIONS: 4.0m

WITH 2/100X3.75mm


LINTEL

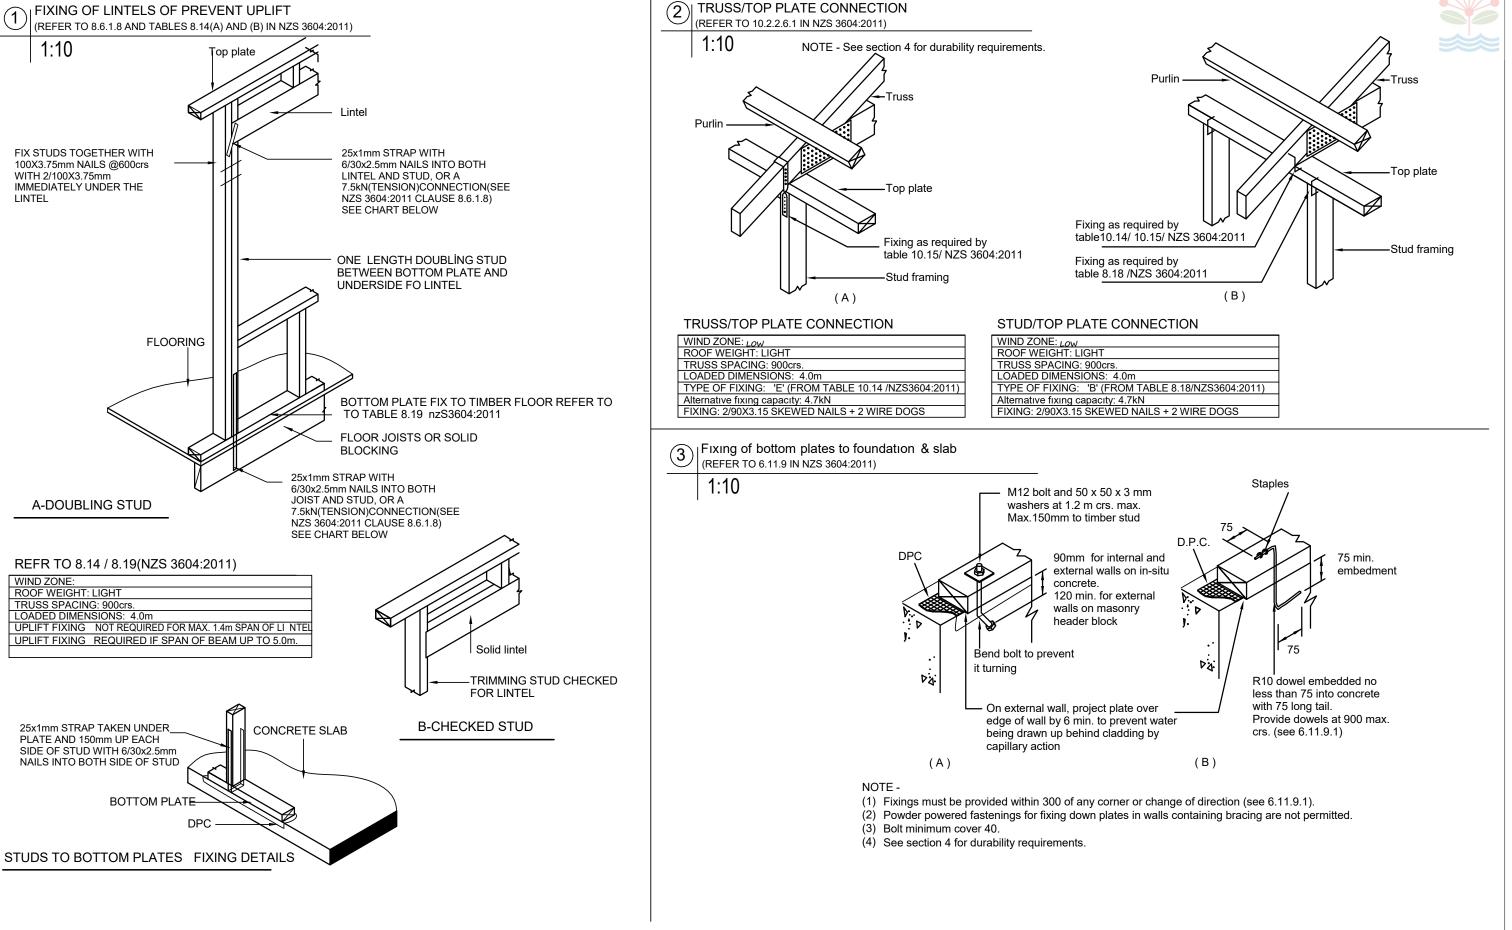

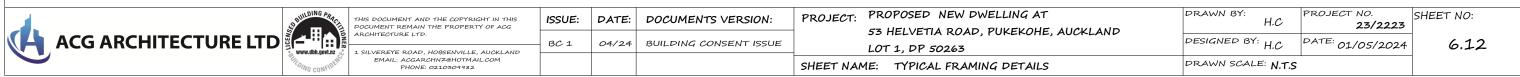


Page 26 of 30 Building Consent BCO10382663 Approved by Auckland Council


SERVICES PENETRATIONS (pipes) REQUIREMENT

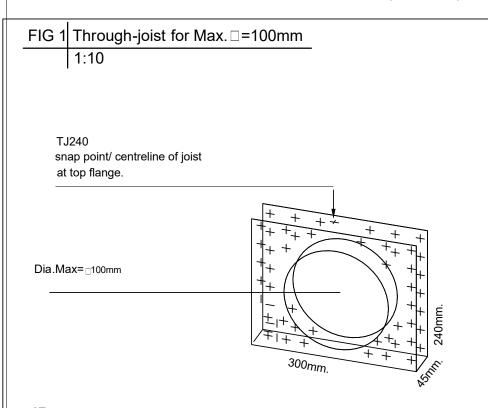

JB: Thru-joist Bracket TJ 240

FIG 2 Throu- top plate (Ref:NZ3604: 2011 Fig.8.20) 1:10

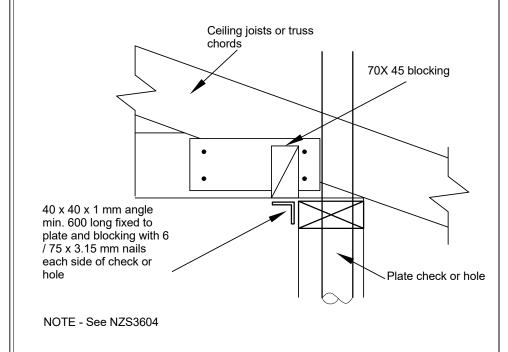

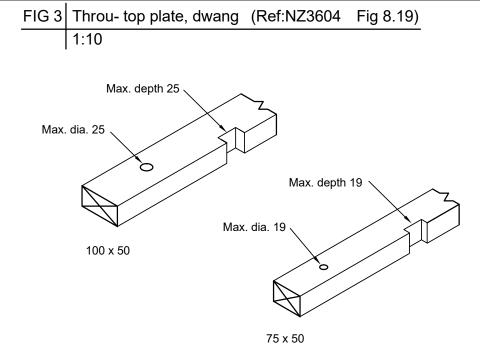


NOTE - See NZS3604:1999 section 4 for durability requirements.

FIG 4 Throu-Studs (Ref:NZ3604 Fig 8.4) 1:10 Max. Max. dia. 19 dia. 25 200 max. Max. depth 19, depth 25, max. max. length 200 length 200 75 wide 100 wide

(1) For diagonal timber bracing the depth of notches in 75 wide timber may be increased to 22 (see 8.5.1.7(b)(i)). 600 min(2) For 100 wide studs the depth of notches and diameter of holes may be increased to 35 where no more than 3 consecutive studs are drilled or notched (see 8.5.1.7(b)(ii)).

(3) Notches in studs to be spaced vertically 600 apart (independent of edge containing the notch).

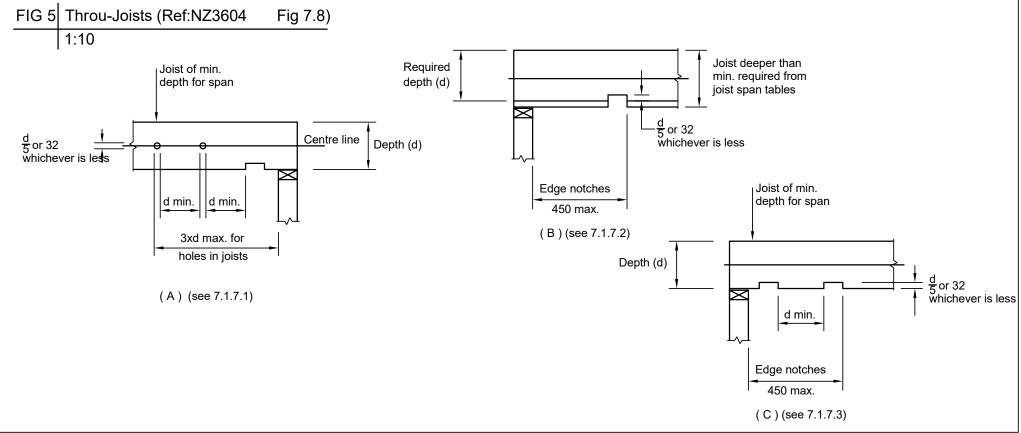






DOCUMENTS VERSION: ISSUE: BUILDING CONSENT ISSUE


PROPOSED NEW DWELLING AT PROJECT: LOT 1, DP 50263


53 HELVETIA ROAD, PUKEKOHE, AUCKLAND SHEET NAME: TYPICAL FRAMING PENETRATION DETAILS DRAWN BY PROJECT NO. SHEET NO: H.C 23/2223 DATE: 01/05/2024


6.13 DRAWN SCALE: N.T.S



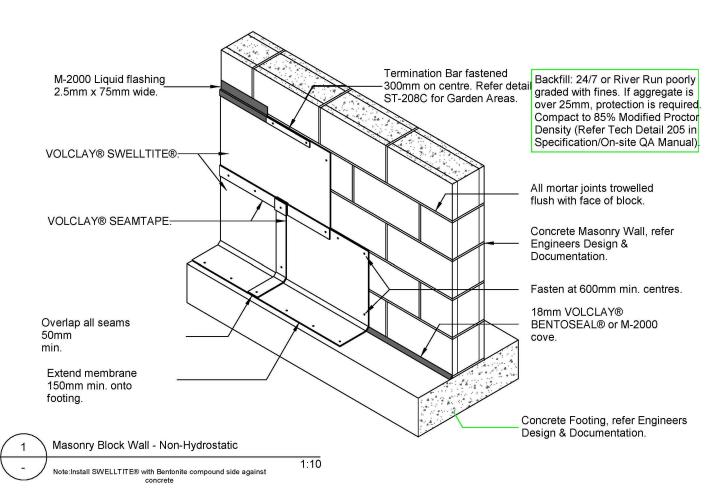

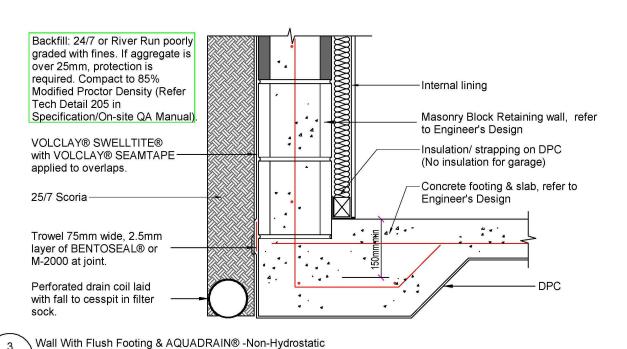

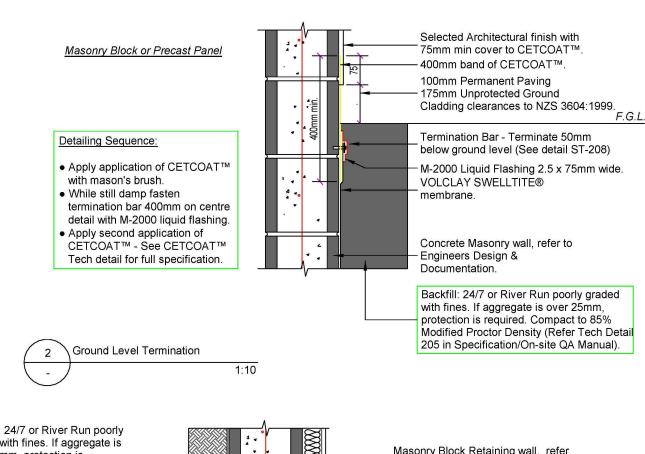

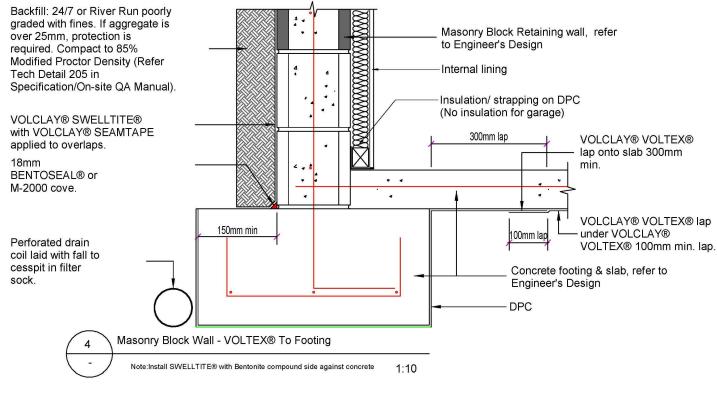





Note:Install SWELLTITE® with Bentonite compound side against concrete 1:10


THIS DOCUMENT AND THE COPYRIGHT IN DOCUMENT REMAIN THE PROPERTY OF AS ARCHITECTURE LTD.


ISSUE:	DATE:	DOCUMENTS VERSION:
 RFI A	06/22	BC RFI - CLOUDED AREAS

PROPOSED NEW DWELLING AT 53 HELVETIA ROAD, PUKEKOHE, AUCKLAND LOT 1, DP 50263

DRAWN BY: H.C23/2223 DESIGNED BY: H.C DATE: 06/22/24 DRAWN SCALE:

SHEET NO: REV A 6.14

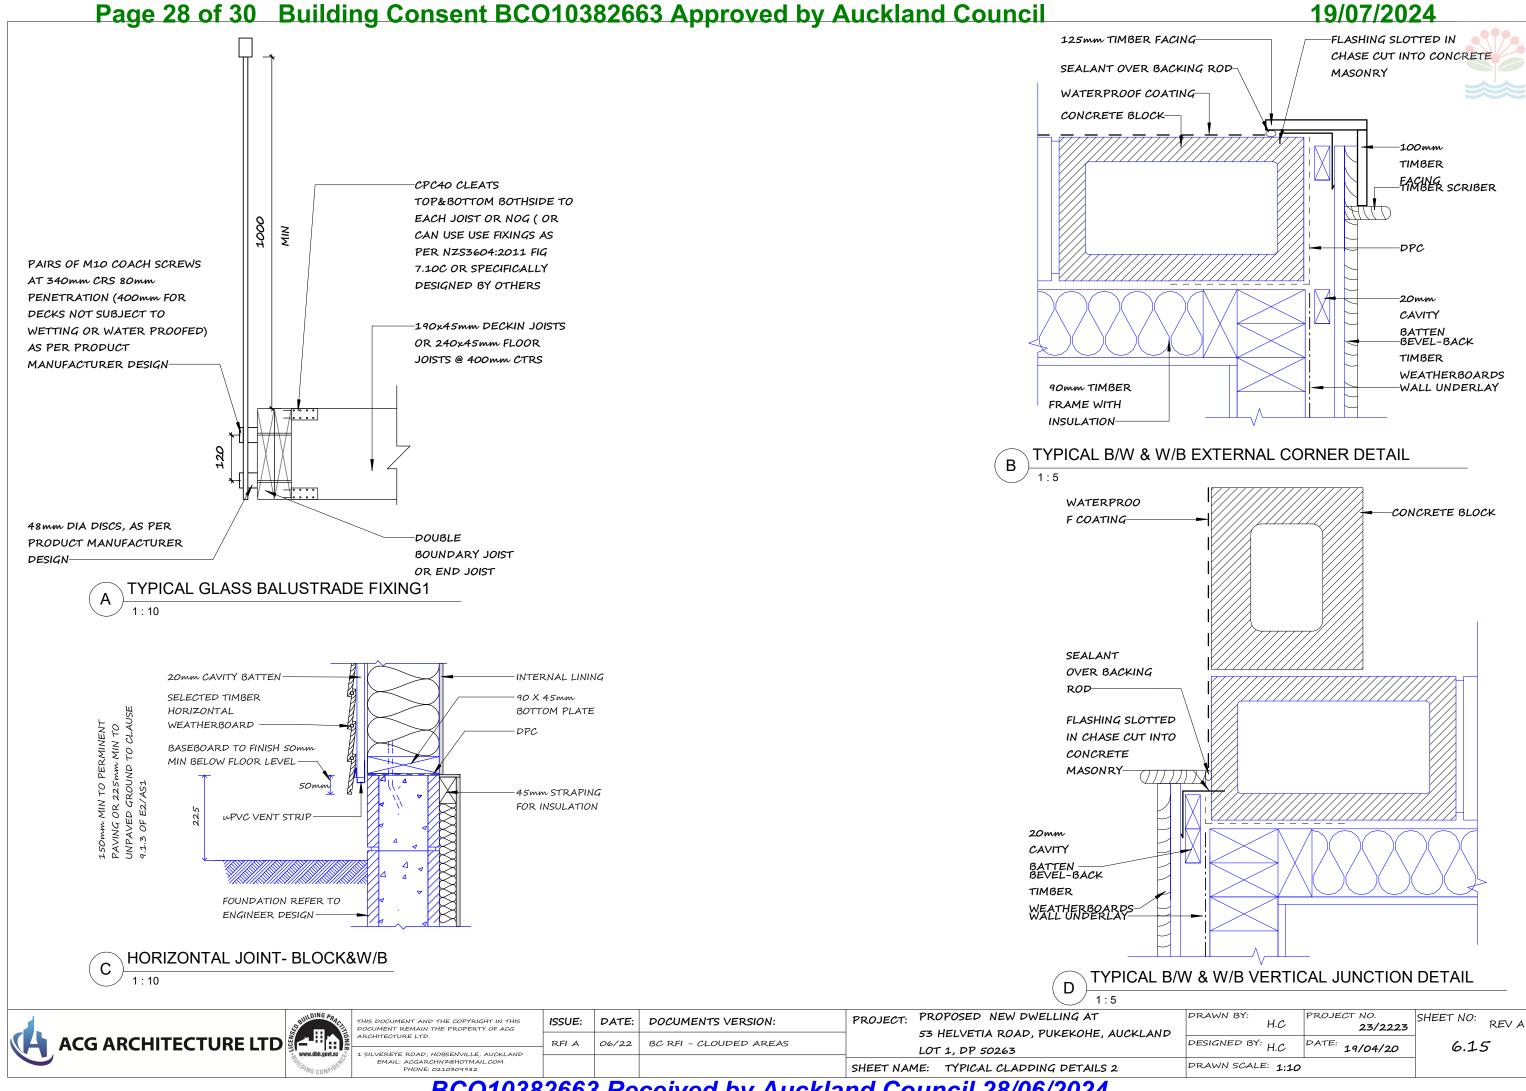

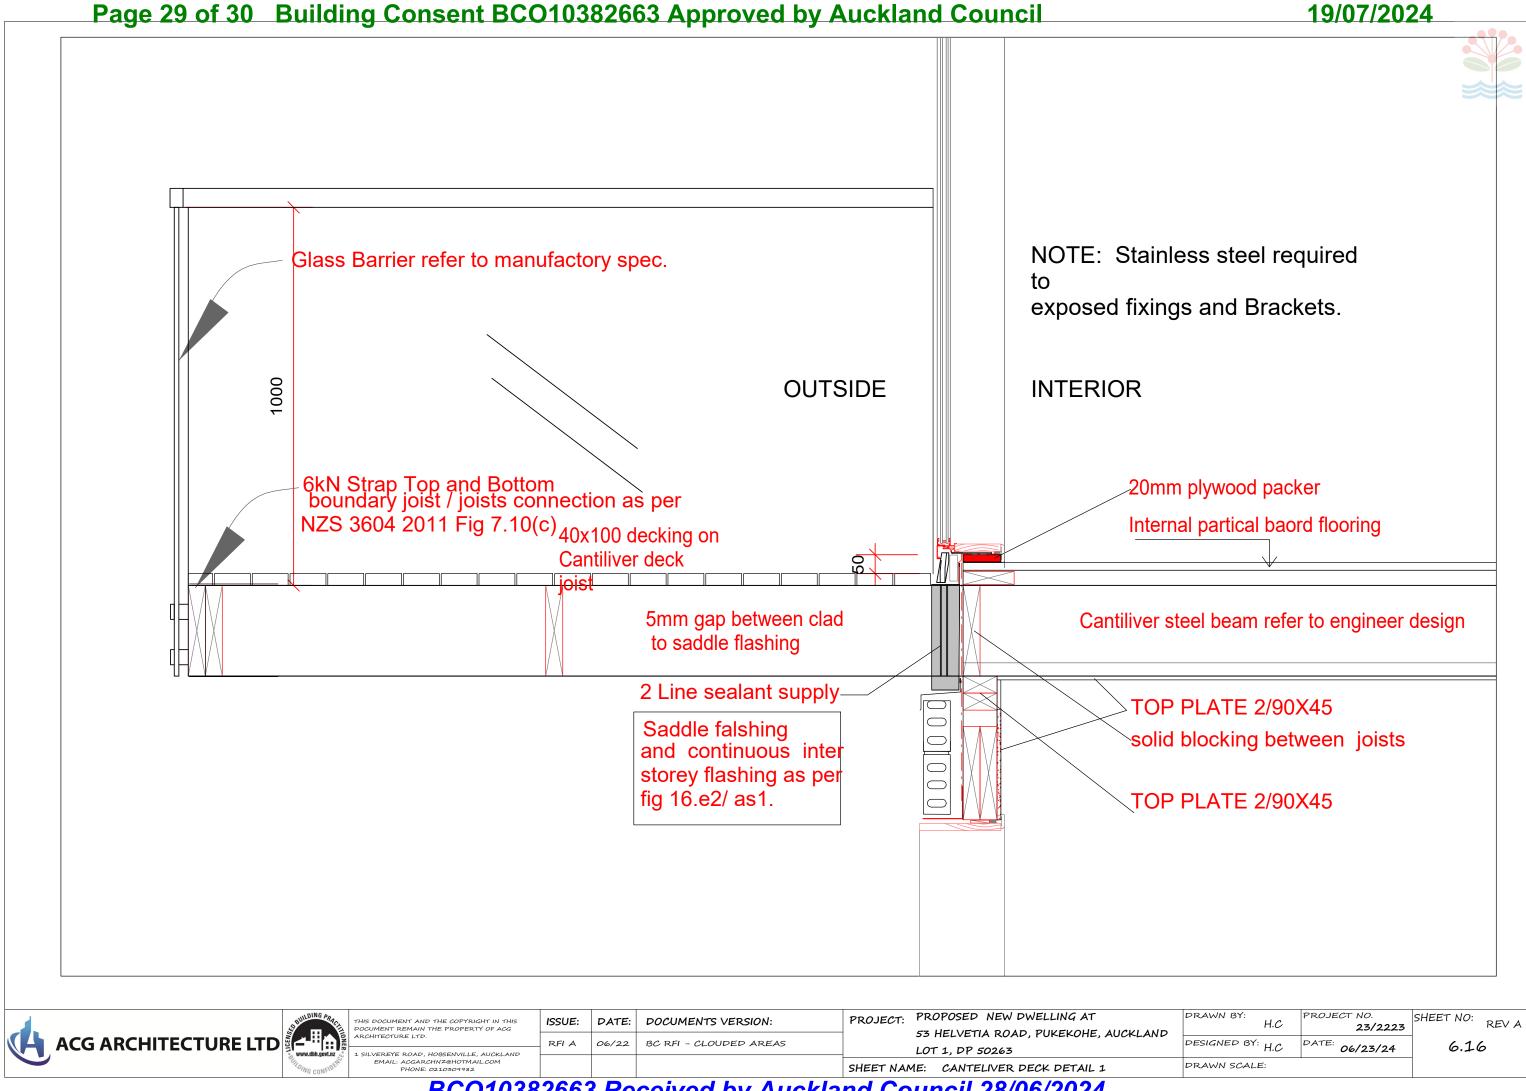

SHEET NAME: CANTELIVER DECK DETAIL 2

DRAWN SCALE: